
### **PART V**

#### **DRAWINGS**

# Plum Creek Watershed - REPAIRS Floodwater Retarding Structure Sites 2, 5, 7, 10, 11, 14 Hays and Caldwell Counties, Texas

SITE 2	Drawing No. TX-EN-0700, 2 sheets, sealed 2/17/17
SITE 5	Drawing No. TX-EN-0703, 1 sheet, sealed 3/6/17
SITE 7	Drawing No. TX-EN-0701, 2 sheets, sealed 2/1/17
SITE 10	Drawing No. TX-EN-0705, 2 sheets, sealed 3/10/17
SITE 11	Drawing No. TX-EN-0704, 2 sheets, sealed 2/17/17
SITE 14	Drawing No. TX-EN-0702, 1 sheet, sealed 3/6/17

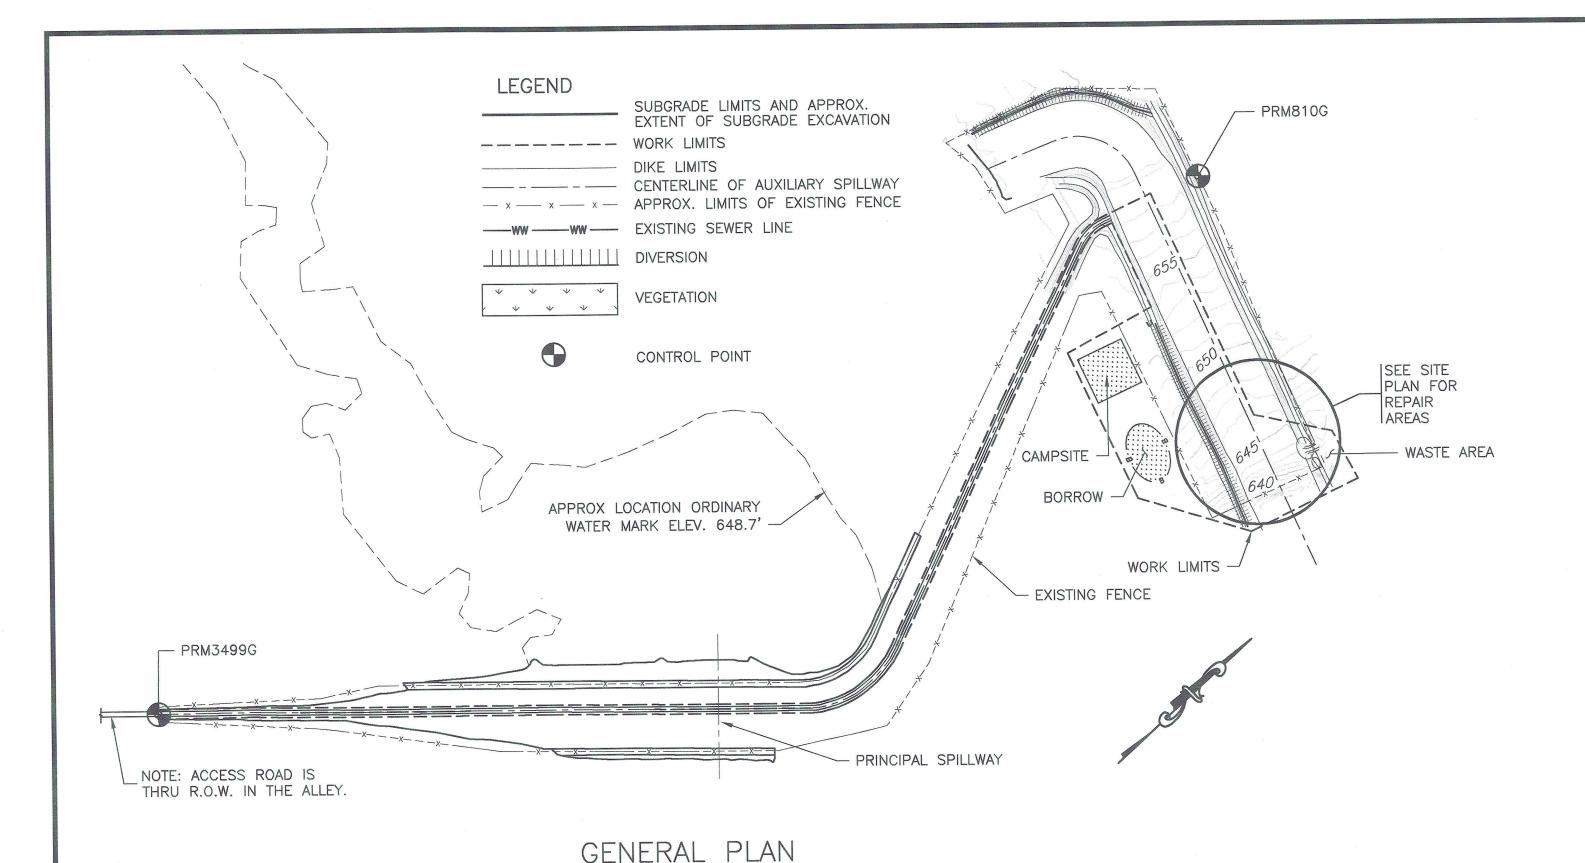


5	)		AL	IGNI	MENT	CURVE I	DATA		
	CURVE #	DELTA (Δ)	D	R	L	P.C.	P.I.	P.T.	Т
	C1	88° 00' 00"	043° 50' 03"	130.7	200.76	N: 13908480.28	N: 13908599.24	STA. 12+00 N: 13908561.19 E: 2330031.72	126.23

SCALE AS SHOWN

CONTROL POINTS						
ELEVATION	DESCRIPTION					
662.60	13906394.58	2329518.22	PRM3499G			
657.60	13908654.02	2330124.95	PRM810G			

### NOTES:


- 1. THE CONTRACTOR SHALL BE LIABLE FOR DAMAGE TO IMPROVEMENTS AND UTILITIES ALONG THE ACCESS ROUTE AND AT OR NEAR THE WORKSITE.
- 2. THE CONTRACTOR SHALL NOTIFY THE OWNERS OF ALL UTILITIES A MINIMUM OF THREE (3) DAYS IN ADVANCE OF INTENT TO PERFORM WORK IN THE VICINITY OF THE AFFECTED UTILITY. THE NOTICE SHALL BE IN WRITING AND A COPY SHALL BE FURNISHED TO THE CONTRACTING OFFICER. UTILITIES MAY EXIST AND NOT BE SHOWN ON THE CONSTRUCTION DRAWINGS. THE SITE SHALL BE CAREFULLY SCRUTINIZED FOR EVIDENCE OF UTILITIES. AT A MINIMUM, PRIOR TO ANY GROUND DISTURBANCE, THE TELEPHONE NUMBER 811 SHALL BE CALLED TO ASCERTAIN IF UNDERGROUND UTILITIES EXIST IN THE GENERAL WORK AREA. CALLING THIS TELEPHONE NUMBER WILL ONLY ASCERTAIN THE EXISTENCE OF UNDERGROUND UTILITIES OWNED BY COMPANIES THAT SUBSCRIBE TO THIS ORGANIZATION. THERE MAY BE OTHER UNDERGROUND UTILITIES IN THE WORK AREA.
- 3. THE APPROXIMATE LOCATIONS OF THE ACCESS ROAD, CONSTRUCTION CAMPSITE, STOCKPILE, BORROW AND WASTE AREAS ARE SHOWN. THE FINAL LOCATIONS OF THESE AREAS SHALL BE DESIGNATED AT THE TIME OF SHOWING OF THE WORKSITE TO PROSPECTIVE BIDDERS.
- 4. THE CONTRACTOR SHALL BE RESPONSIBLE FOR FURNISHING, INSTALLING, AND MAINTAINING ALL BARRICADES, WARNING SIGNS, TRAFFIC CONTROL DEVICES, ETC. NECESSARY TO CONTROL TRAFFIC AND PROVIDE FOR PUBLIC SAFETY AT THE ENTRANCE TO THE SITE (SEE CONSTRUCTION SPECIFICATION 9).
- 5. SUITABLE MATERIAL FROM EXCAVATIONS SHALL BE PROCESSED AND USED FOR THE EARTHFILL MATERIALS. UNSUITABLE MATERIALS SHALL BE PLACED IN A WASTE AREA OR OTHER AREAS APPROVED BY THE ENGINEER. EARTH MATERIALS NEEDED IN EXCESS OF REQUIRED EXCAVATIONS SHALL BE OBTAINED FROM THE BORROW AREA(S). (SEE CONSTRUCTION SPECIFICATIONS 21, 23, 420, AND 446).
- 6. A MINIMUM OF 6" OF TOPSOIL SHALL BE PLACED ON ALL EARTHWORK REPAIR AREAS (SEE CONSTRUCTION SPECIFICATION 26).
- 7. CONSTRUCTION ACTIVITIES SHALL NOT OCCUR OUTSIDE THE DESIGNATED WORK LIMITS, UNLESS OTHERWISE AUTHORIZED.
- 8. REMOVAL OR STRIPPING OF SOIL MATERIALS INCLUDING TOPSOIL AND LOW DENSITY OR DISPLACED MATERIALS WILL BE NECESSARY TO PROVIDE A SUITABLE WORKING AREA FOR THE CONSTRUCTION EQUIPMENT. THE APPROXIMATE LIMITS OF THE REMOVAL ARE SHOWN ON THE DRAWINGS. REMOVAL OF ADDITIONAL MATERIALS BEYOND THE LIMITS SHOWN MAY BE REQUIRED TO ENSURE A SUITABLE FOUNDATION EXISTS ON WHICH TO PLACE EARTHFILL AND/OR ROCK. (SEE CONSTRUCTION SPECIFICATION 420.)
- 9. THE EXISTING NATURAL GROUND SHOWN FOR THE SITE IS BASED ON SURVEYED CONDITIONS AS THEY EXISTED IN FEBRUARY 2016. CHANGES IN SITE CONDITIONS PRIOR TO CONSTRUCTION MAY NECESSITATE ADJUSTMENTS TO THE GRADES AND ELEVATIONS SHOWN. THE FINAL GRADES AND ELEVATIONS FOR ALL WORKS OF IMPROVEMENTS SHOWN ARE APPROXIMATE AND SHALL BE ADJUSTED IN THE FIELD BY THE ENGINEER TO BEST FIT THE TOPOGRAPHY OF THE SITE, IF NECESSARY.
- 10. THE CONTROL POINTS SHOWN ARE TO BE USED TO ESTABLISH HORIZONTAL AND VERTICAL CONTROL.

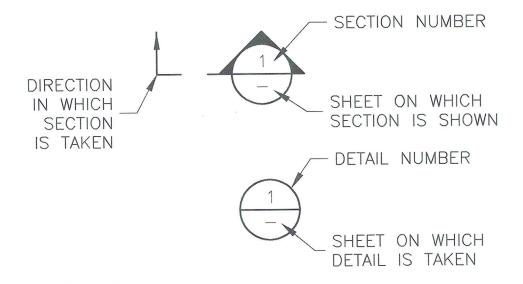

#### PEDESTRIAN SAFETY NOTES:

- 1. CAMPSITE AND BORROW AREA SHALL NOT ENCROACH UPON DIRT HIKING TRAILS.
- 2. HIKING TRAILS ARE TO BE LOCATED AT THE TIME OF THE SITE SHOWING AND SHALL BE MAINTAINED TO PRE-CONSTRUCTION CONDITIONS AT ALL TIMES.
- 3. PEDESTRIAN TRAFFIC IS TO BE EXPECTED IN THE AREA AND PRECAUTIONS SHOULD BE TAKEN TO ENSURE PEDESTRIAN SAFETY.



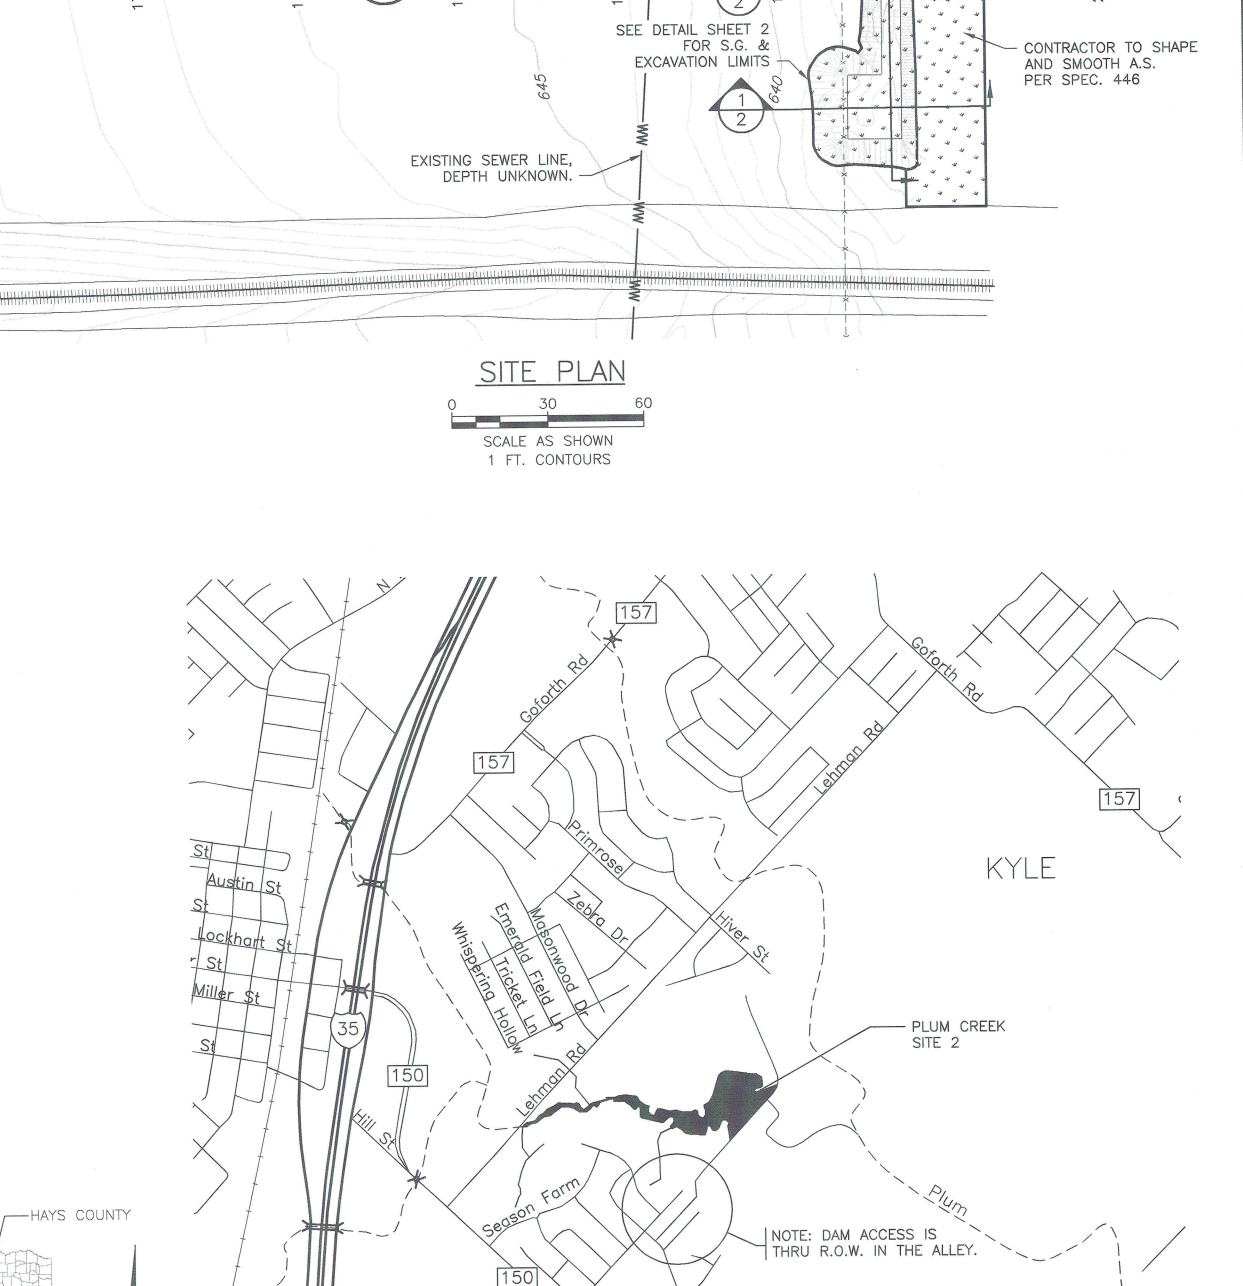

SITE NO. 2 IS LOCATED 1 MILE EAST OF KYLE,

VICINITY MAP

NOT TO SCALE

HAYS COUNTY, TEXAS.

→ WASTE AREA →

EXISTING FENCE

APPROXIMATE LOCATION FOR ± 6" DEPTH,


STA.16+50 N: 13908425.53

E: 2330460.78

CONTRACTOR TO SHAPE, SMOOTH AND

±10' RADIUS DEPRESSION.

BLEND TO EXISTING GROUND.

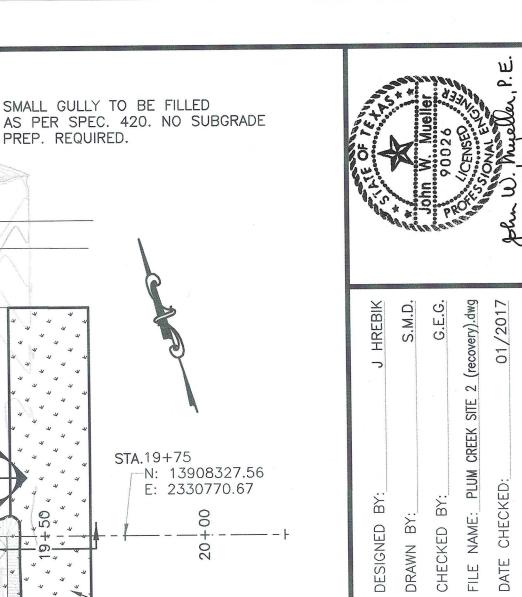

SMALL GULLY TO BE FILLED

STA.19+75


E: 2330770.67


PREP. REQUIRED.

S


REVISIONS

DRAWING NO. TX-EN-0700

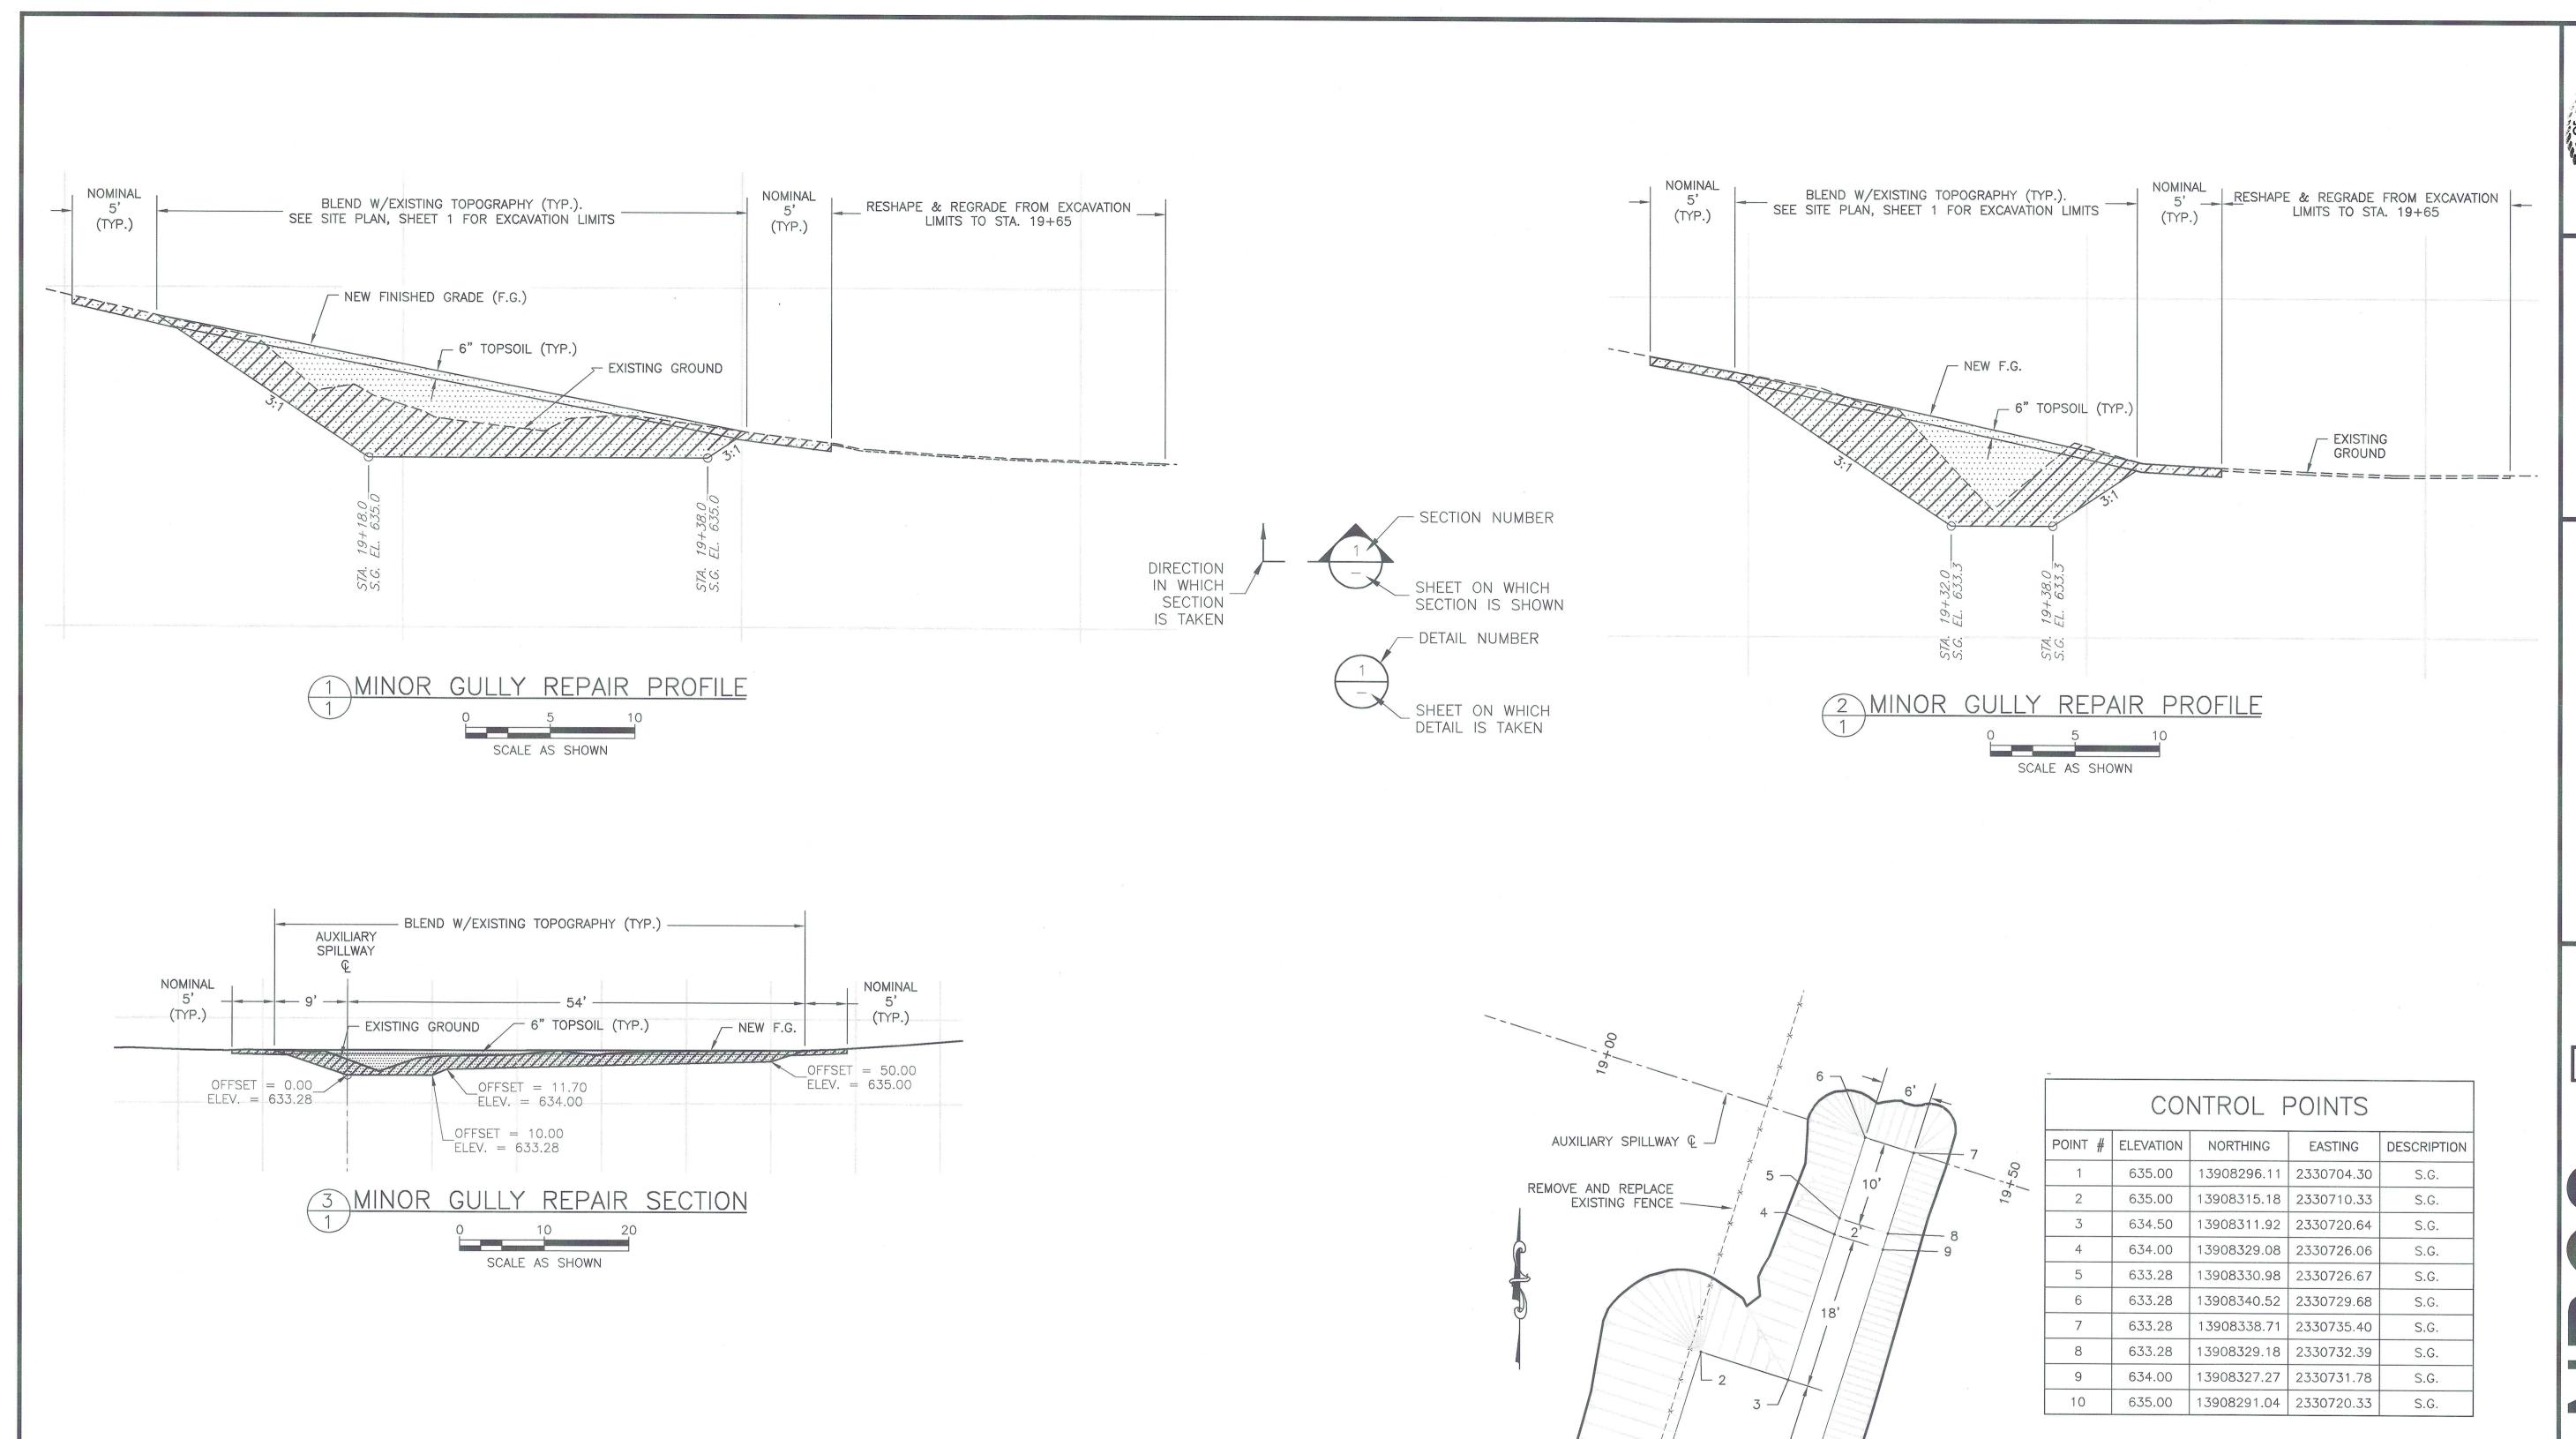

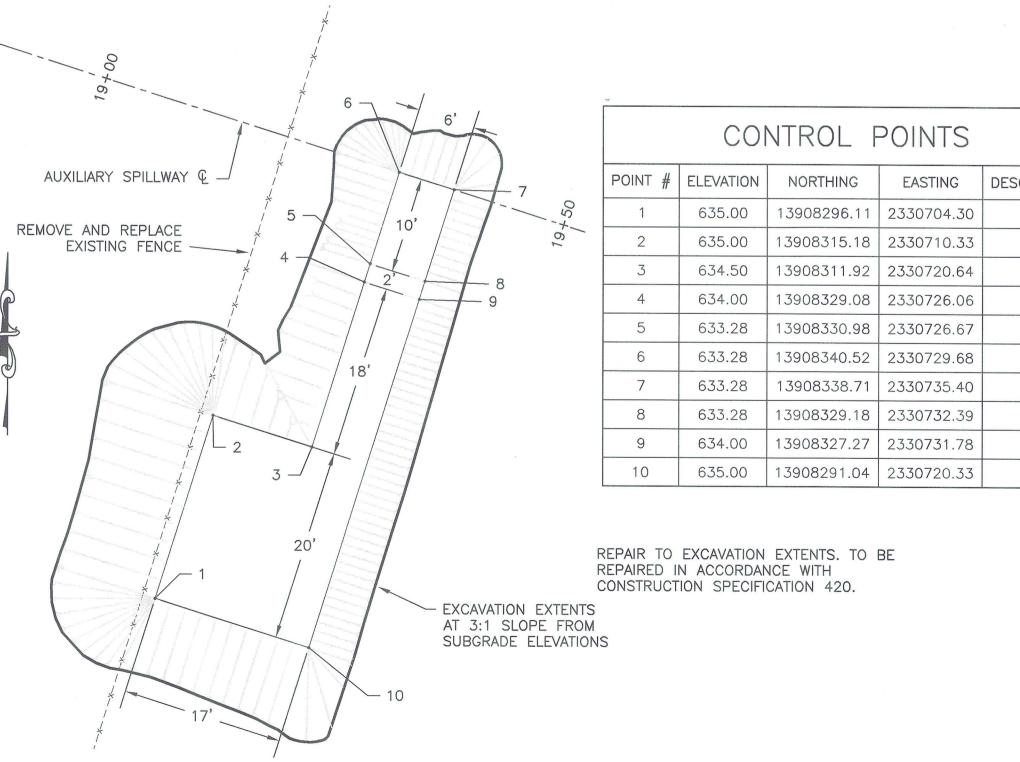


PLAN OF SUBGRADE ELEV. & EXCAVATION EXTENTS

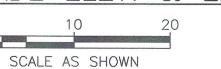


REVISIONS DRAWING NO.

TX-EN-0700

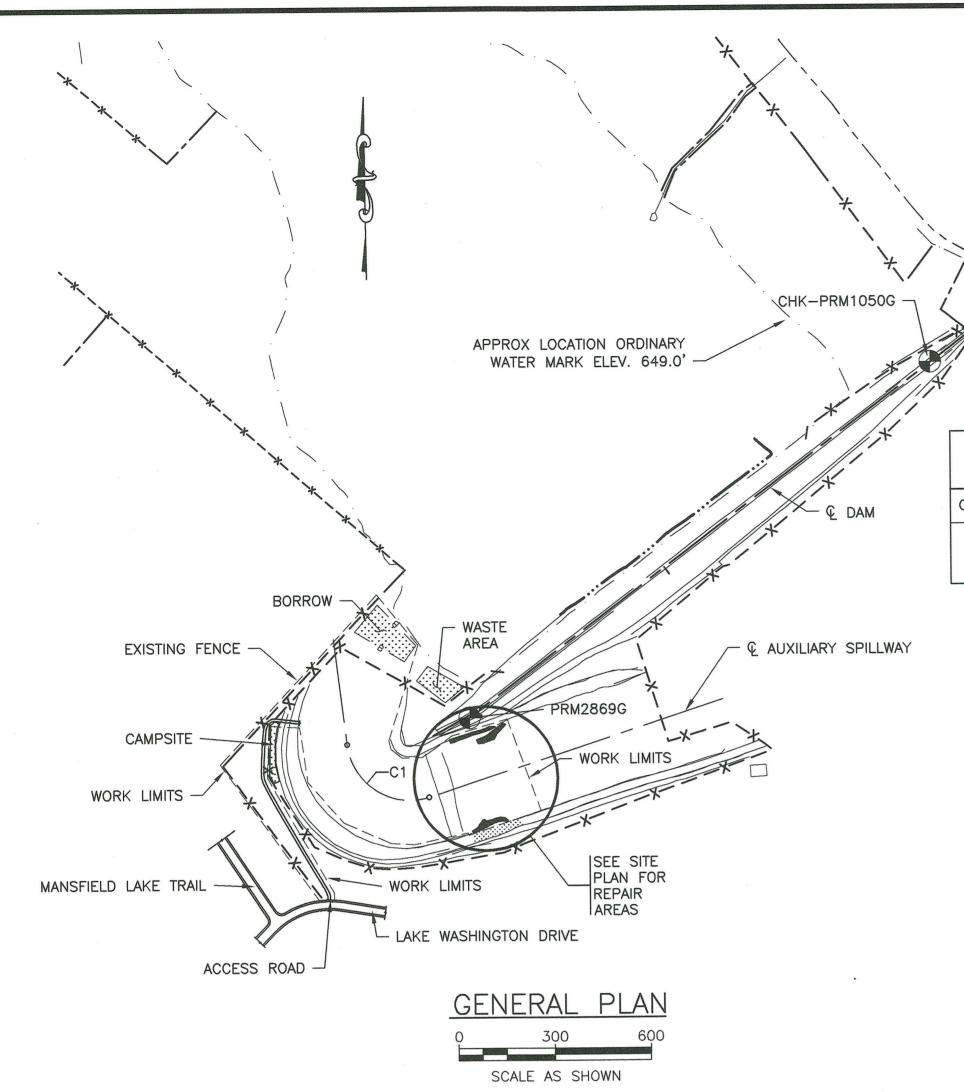

## NOTES:


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- 10. THE CONTROL POINTS SHOWN ARE TO BE USED TO ESTABLISH HORIZONTAL AND VERTICAL CONTROL.

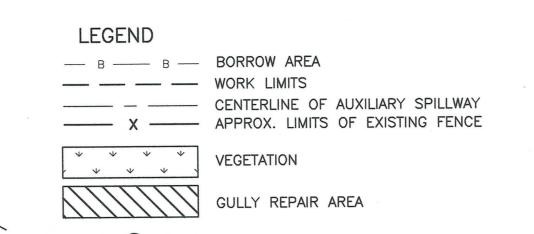

CONTROL POINT

		AL	IGNN	MENT	CURVE [	DATA		
CURVE #	DELTA (Δ)	D	R	L	P.C.	P.I.	P.T.	Т
C1	100° 31' 05"	028* 57' 07"	197.9	347.19	STA. 6+49.8 N: 13913365.02 E: 2334908.66	N: 13913128.70	STA. 9+97 N: 13913199.80 E: 2335164.26	238.02

COORDINATES						
POINT #	NORTHING	EASTING	ELEVATION			
CHK-PRM1050G 13914548.18 2336739.67 671.06						
PRM2869G 13913446.32 2335292.15 671.10						

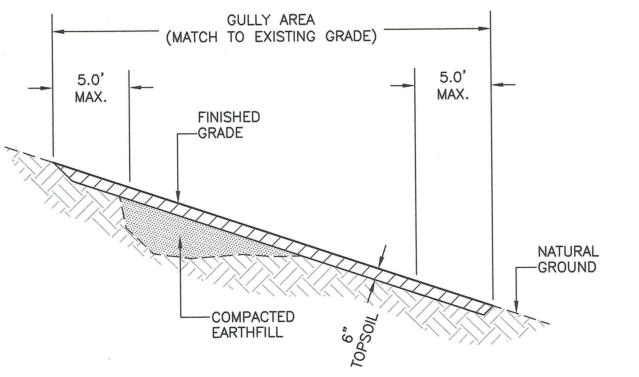


CONSTRUCTION NOTES: 1. THE APPROXIMATE LOCATIONS AND AREAS OF THE GULLY AREAS TO BE REPAIRED BY SHAPING AND SMOOTHING ARE SHOWN IN THE DRAWINGS. THE FINAL EXTENTS SHALL BE STAKED BY THE ENGINEER.


2. CONSTRUCTION ACTIVITIES SHALL BE CONDUCTED TO MINIMIZE IMPACTS TO THE SURROUNDING VEGETATION. CARE SHALL BE TAKEN TO ENSURE THAT THE MINIMUM CONSTRUCTION FOOTPRINT REQUIRED TO ACCOMPLISH THE JOB IS USED AND DAMAGE TO THE SURROUNDING VEGETATION IS KEPT TO A MINIMUM. 3. THE GULLY AREAS SHALL BE REPAIRED IN ACCORDANCE WITH CONSTRUCTION


SPECIFICATION 420, BRINGING THE FINISHED SURFACE UP TO MATCH THE EXISTING GRADE.

# TYP. GULLY REPAIR DETAIL


NOT TO SCALE

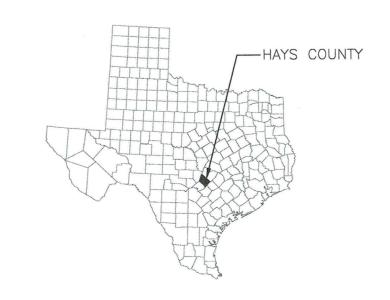

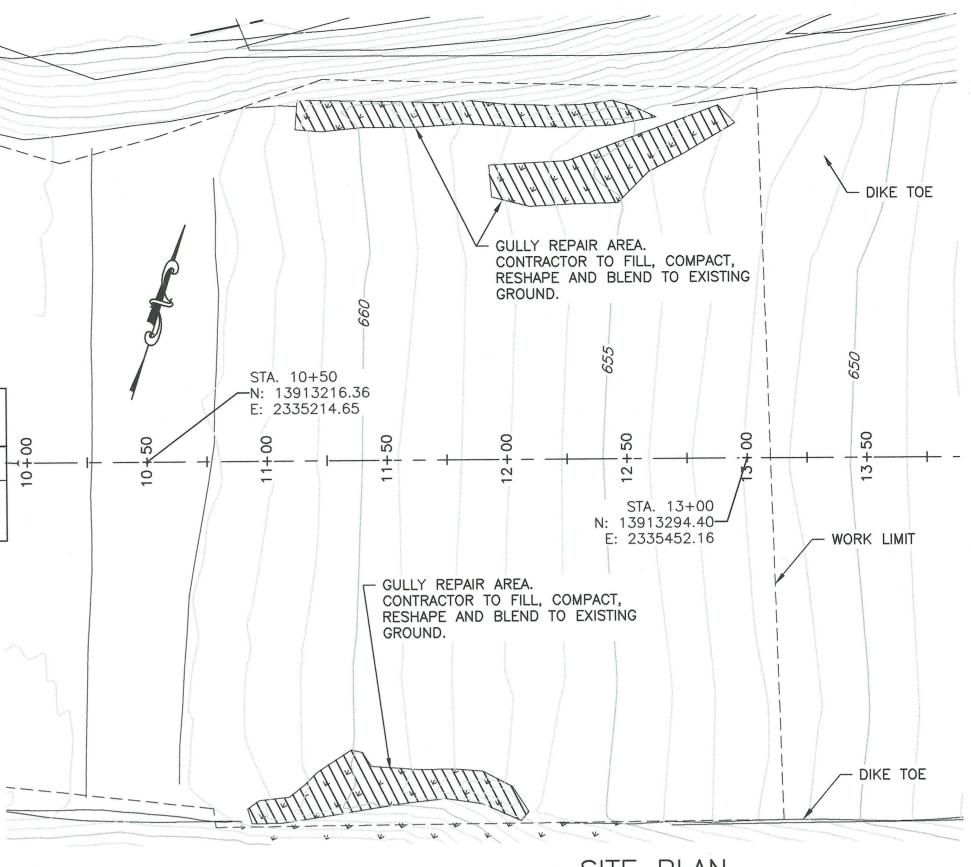

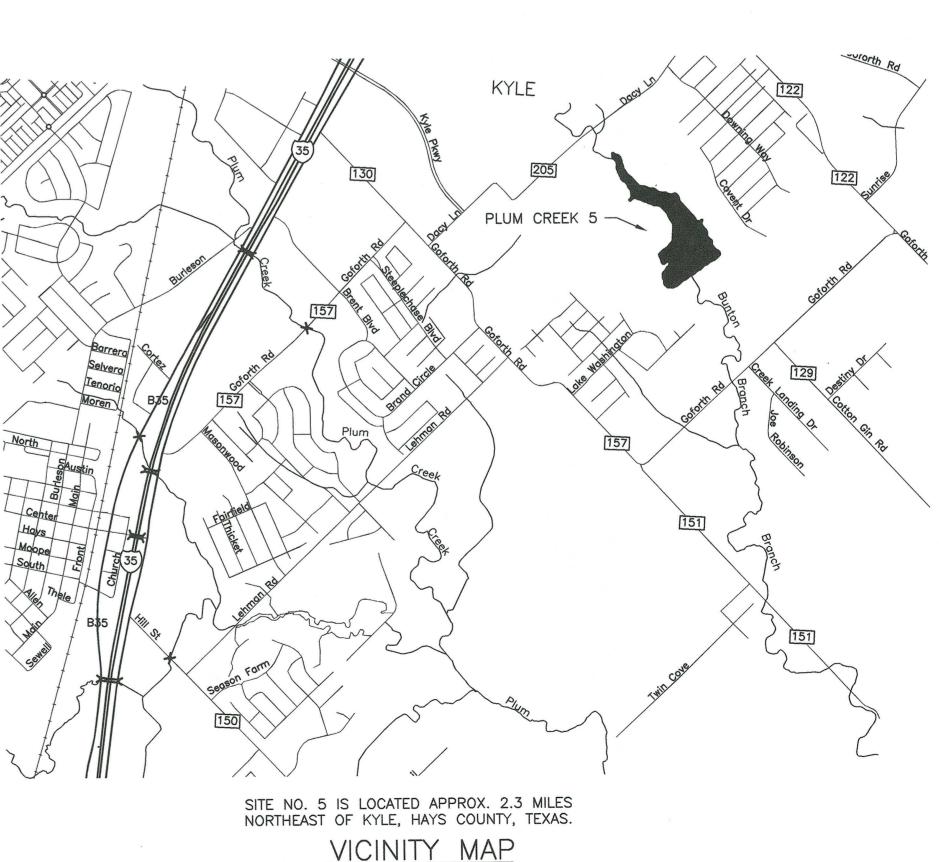


NOT TO SCALE

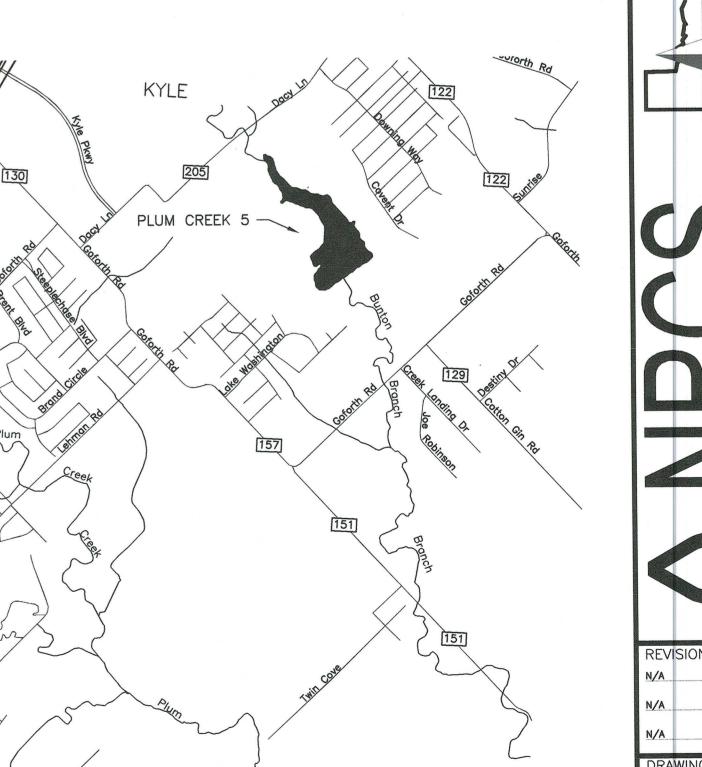

SCALE AS SHOWN 1 FT CONTOUR INTERVAL

TX-EN- 0703

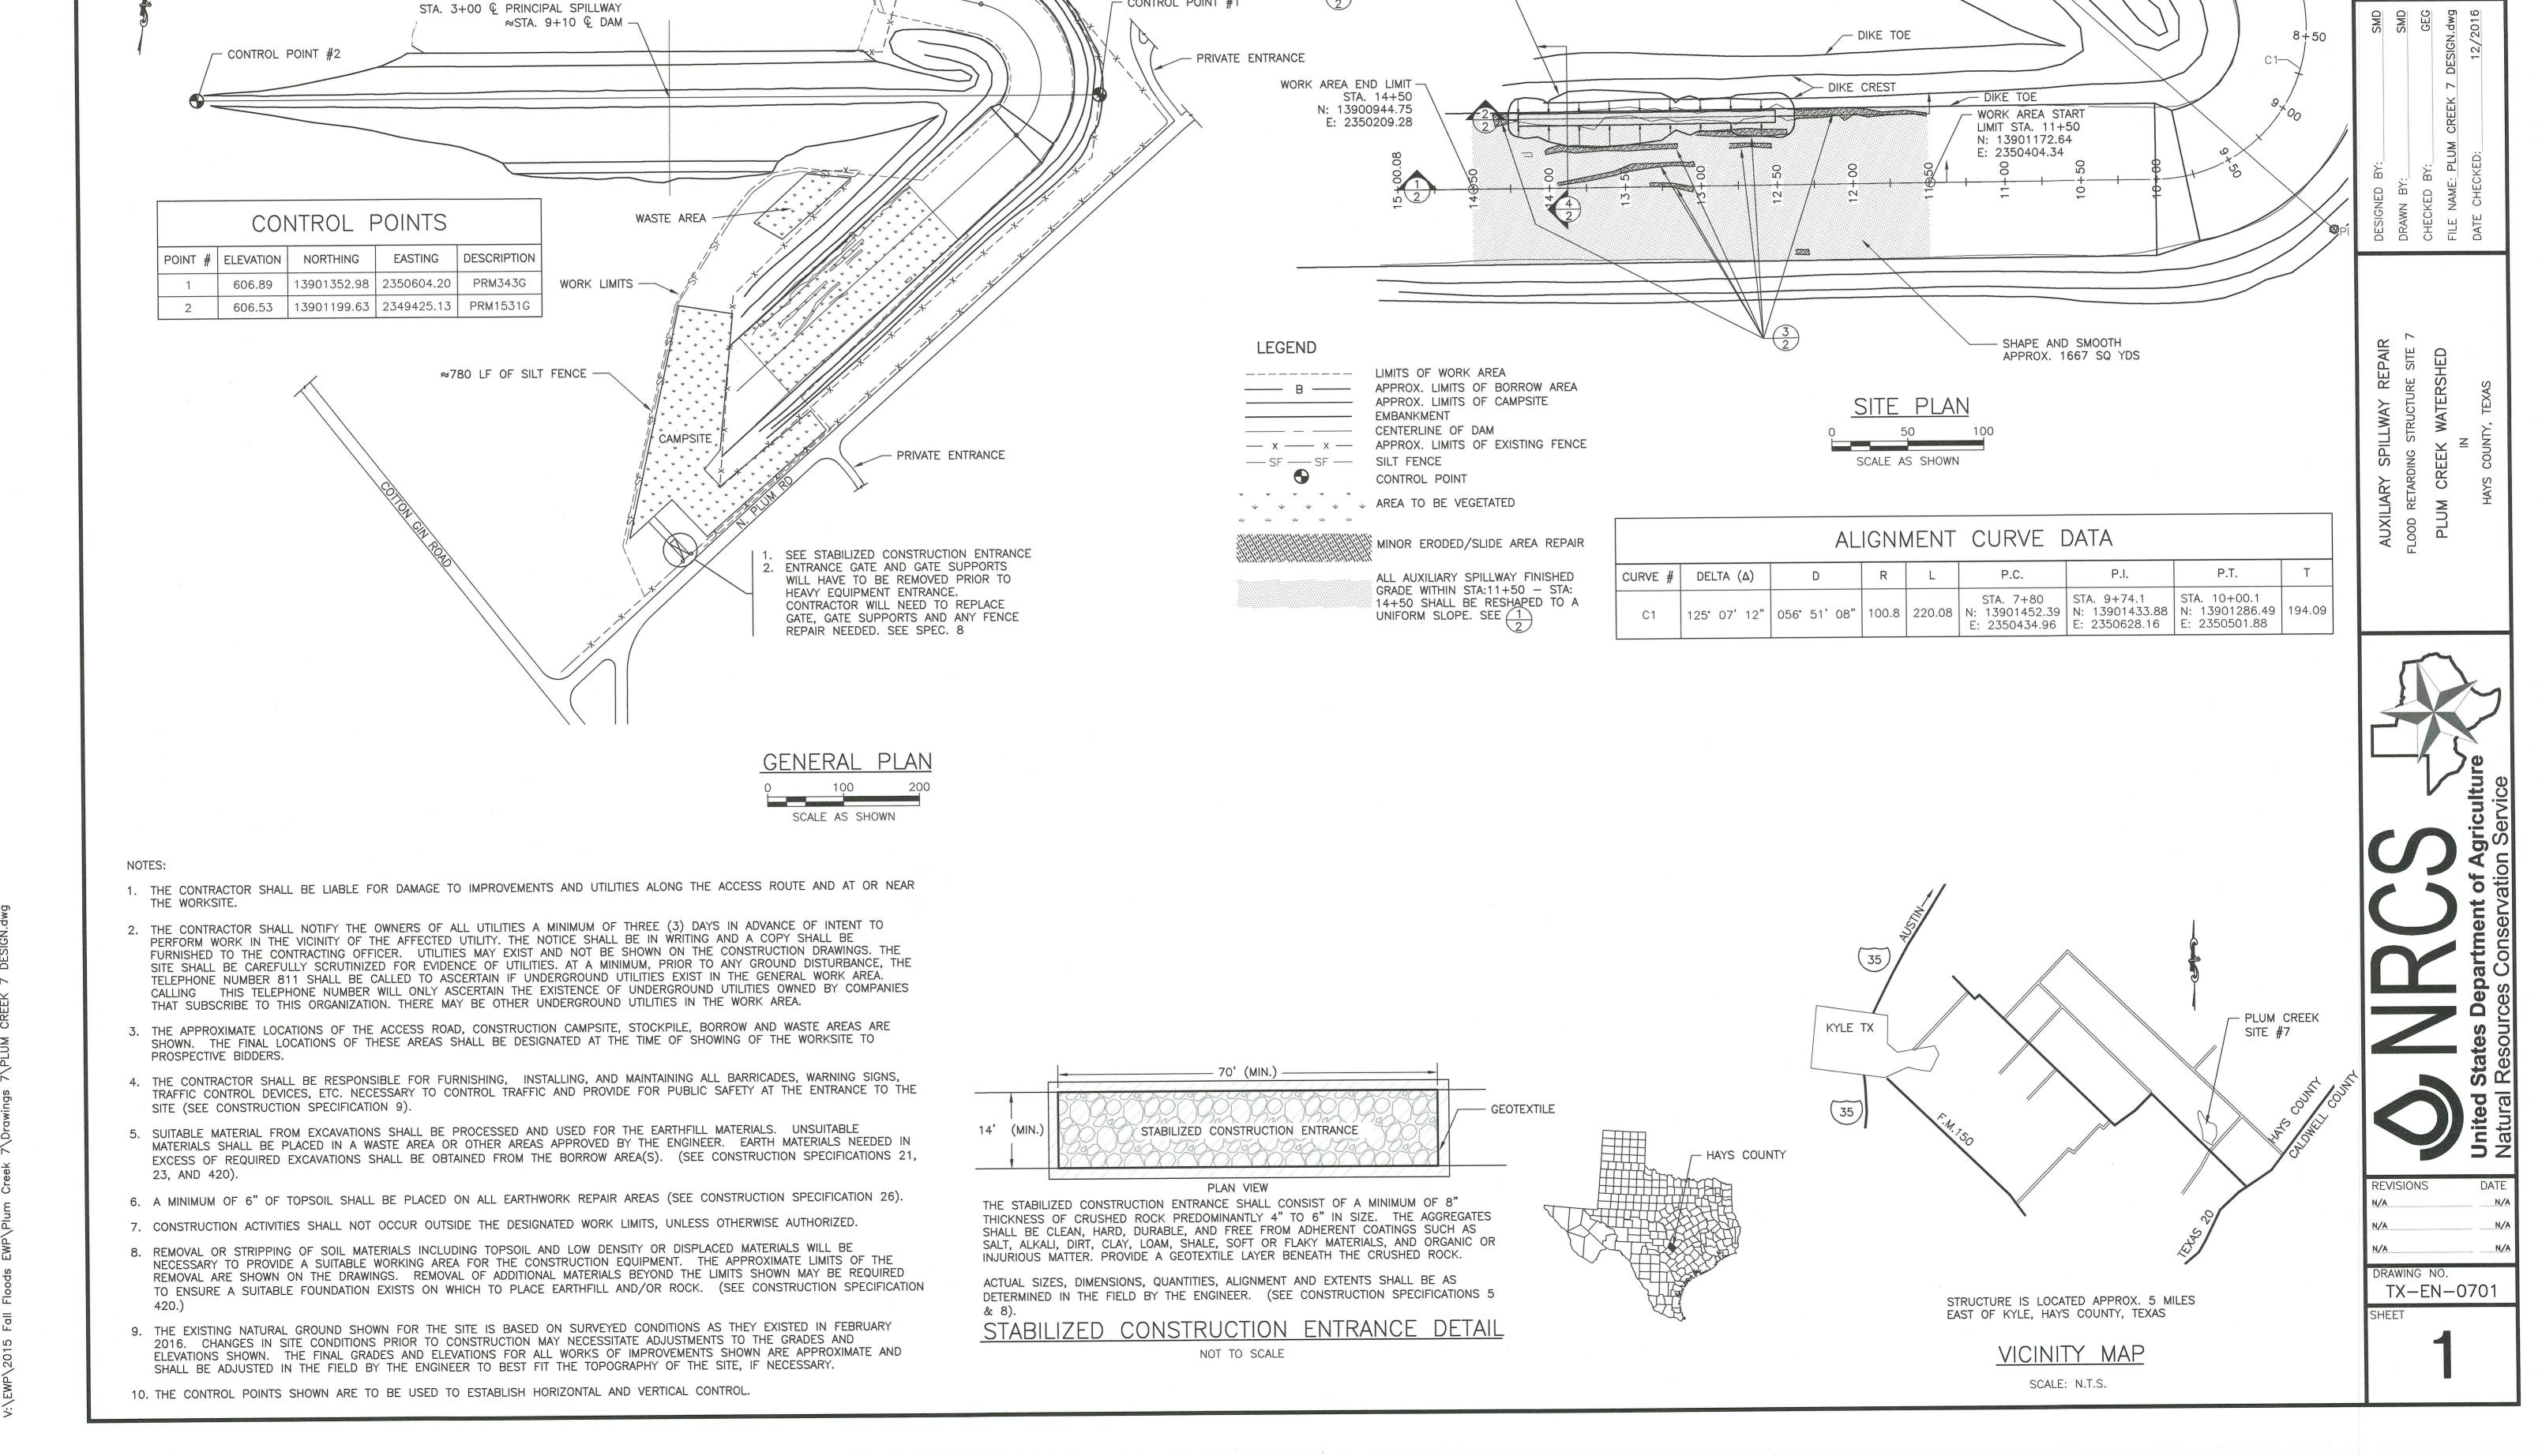

MAJOR GULLY REPAIR AREA -MIN. GRADING EXTENTS STA. 12+50 TO STA. 14+19 SEE 4 FOR TYPICAL SECTION


- CONTROL POINT #1

≈300 LF OF SILT FENCE

- APPROX. LOCATION ORDINARY HIGH

WATER MARK ELEV. 590.60

STA. 7+00 N: 13901460.01 E: 2350355.32 -

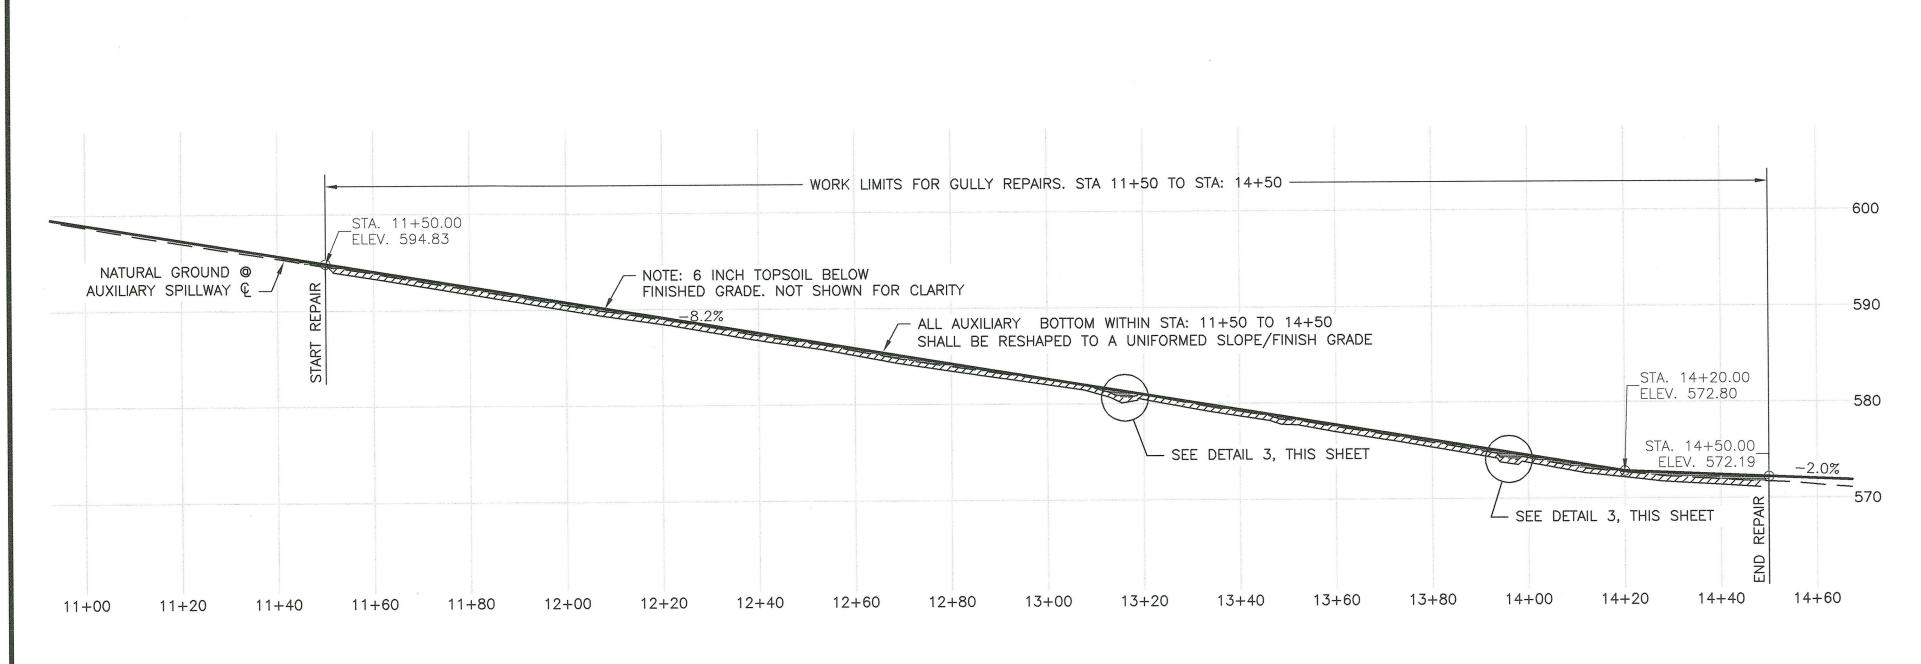


1 PROFILE ON CENTERLINE OF AUXILIARY SPILLWAY

1 OF AUXILIARY SPILLWAY


1 OF AUXILIARY SPILLWAY


SCALE AS SHOWN

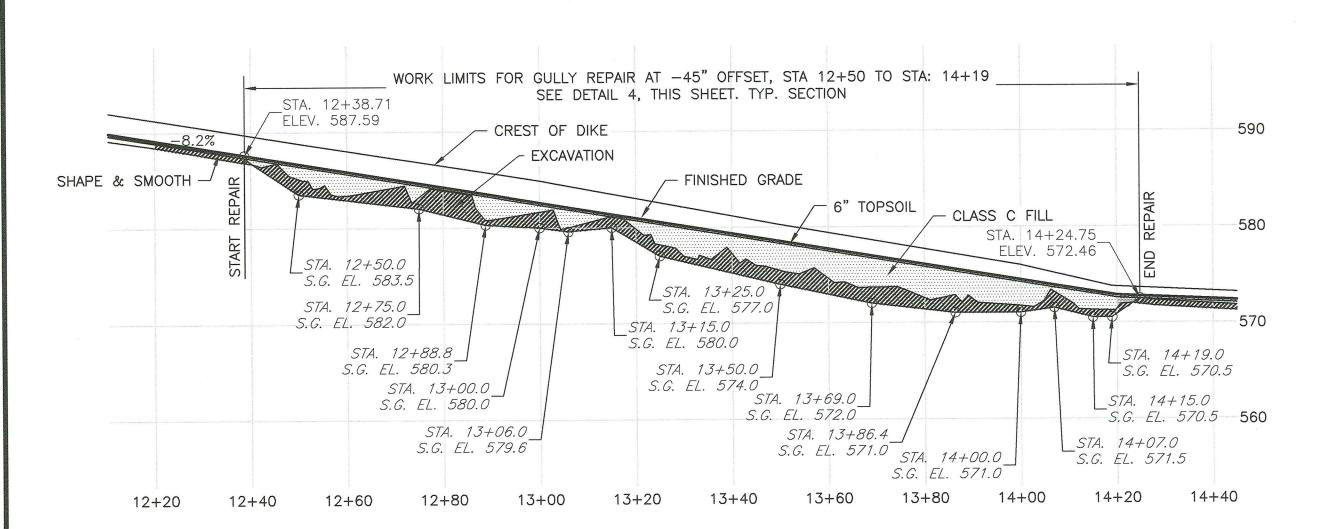

PROFILE ON CENTERLINE @ 45' RIGHT OF AUXILIARY SPILLWAY CENTERLINE

H O 20 40

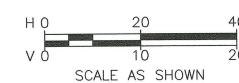

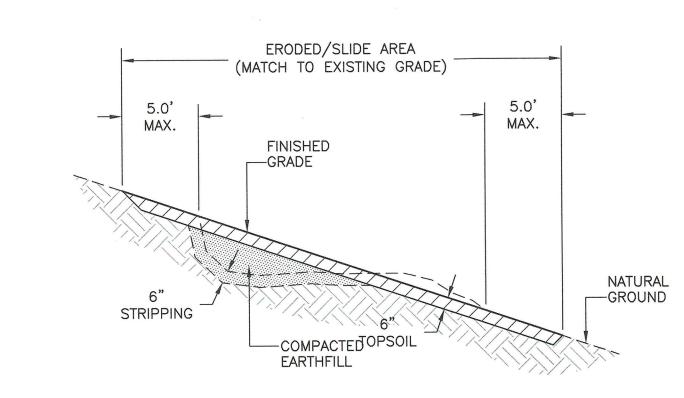

CONSTRUCTION NOTES:

1. THE APPROXIMATE LOCATIONS AND AREAS OF THE SLIDE/ERODED AREAS TO BE REPAIRED BY SHAPING AND SMOOTHING ARE SHOWN IN THE DRAWINGS. THE FINAL EXTENTS SHALL BE STAKED BY THE ENGINEER.

2. CONSTRUCTION ACTIVITIES SHALL BE CONDUCTED TO MINIMIZE IMPACTS TO THE SURROUNDING VEGETATION. CARE SHALL BE TAKEN TO ENSURE THAT THE MINIMUM CONSTRUCTION FOOTPRINT REQUIRED TO ACCOMPLISH THE JOB IS USED AND DAMAGE TO THE SURROUNDING VEGETATION IS KEPT TO A MINIMUM.

3. THE GULLY AREAS SHALL BE REPAIRED IN ACCORDANCE WITH CONSTRUCTION


3. THE GULLY AREAS SHALL BE REPAIRED IN ACCORDANCE WITH CONSTRUCTION SPECIFICATION 420, BRINGING THE FINISHED SURFACE UP TO MATCH THE EXISTING GRADE.

3 TYP. MINOR GULLY REPAIR DETAIL

NOT TO SCALE

NOTES:

1. ALL AREAS WITHIN THE WORK LIMITS SHALL BE SHAPED AND SMOOTHED ACCORDING TO SPEC. 446, UNLESS IDENIFIED AS A MAOR OR MINOR GULLY ON SHEET 1

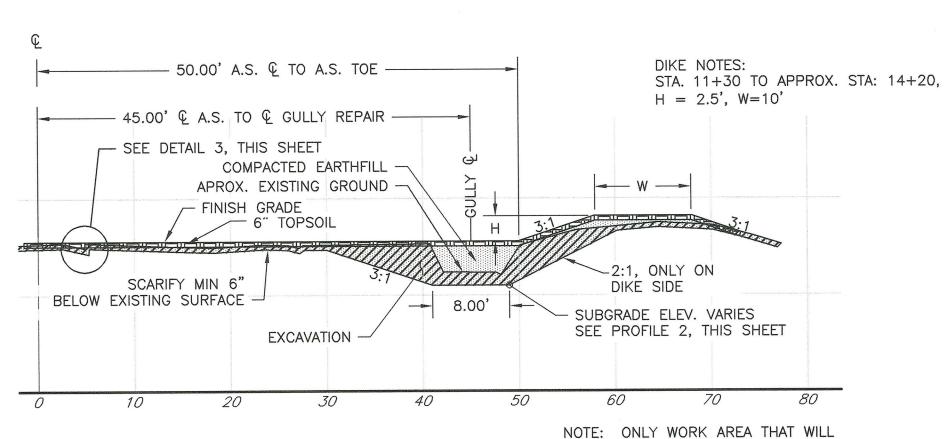

INCLUDE DIKE WORK WILL BE SHOWN ON THE SITE PLAN, SHEET 1, MAJOR GULLY REPAIR EXTENTS LIMITS. ALL WORK WITHIN MAJOR GULLY REPAIR TO BE CLASS C COMPACTION.

TYP. MAJOR GULLY REPAIR. STA: 12+50 TO 14+19

O 10 20

SCALE AS SHOWN



CREEK 7 DESIGN.dwg

DRAWN BY:

CHECKED BY:

FILE NAME: PLUM CREEK 7 DE

DATE CHECKED:

PROFILE & DETAILS

"LOOD RETARDING STRUCTURE SITE

PLUM CREEK WATERSHED

IN

ates Department of Agriculture
esources Conservation Service


REVISIONS DA

DRAWING NO.


TX-EN-0701


SHEET

2

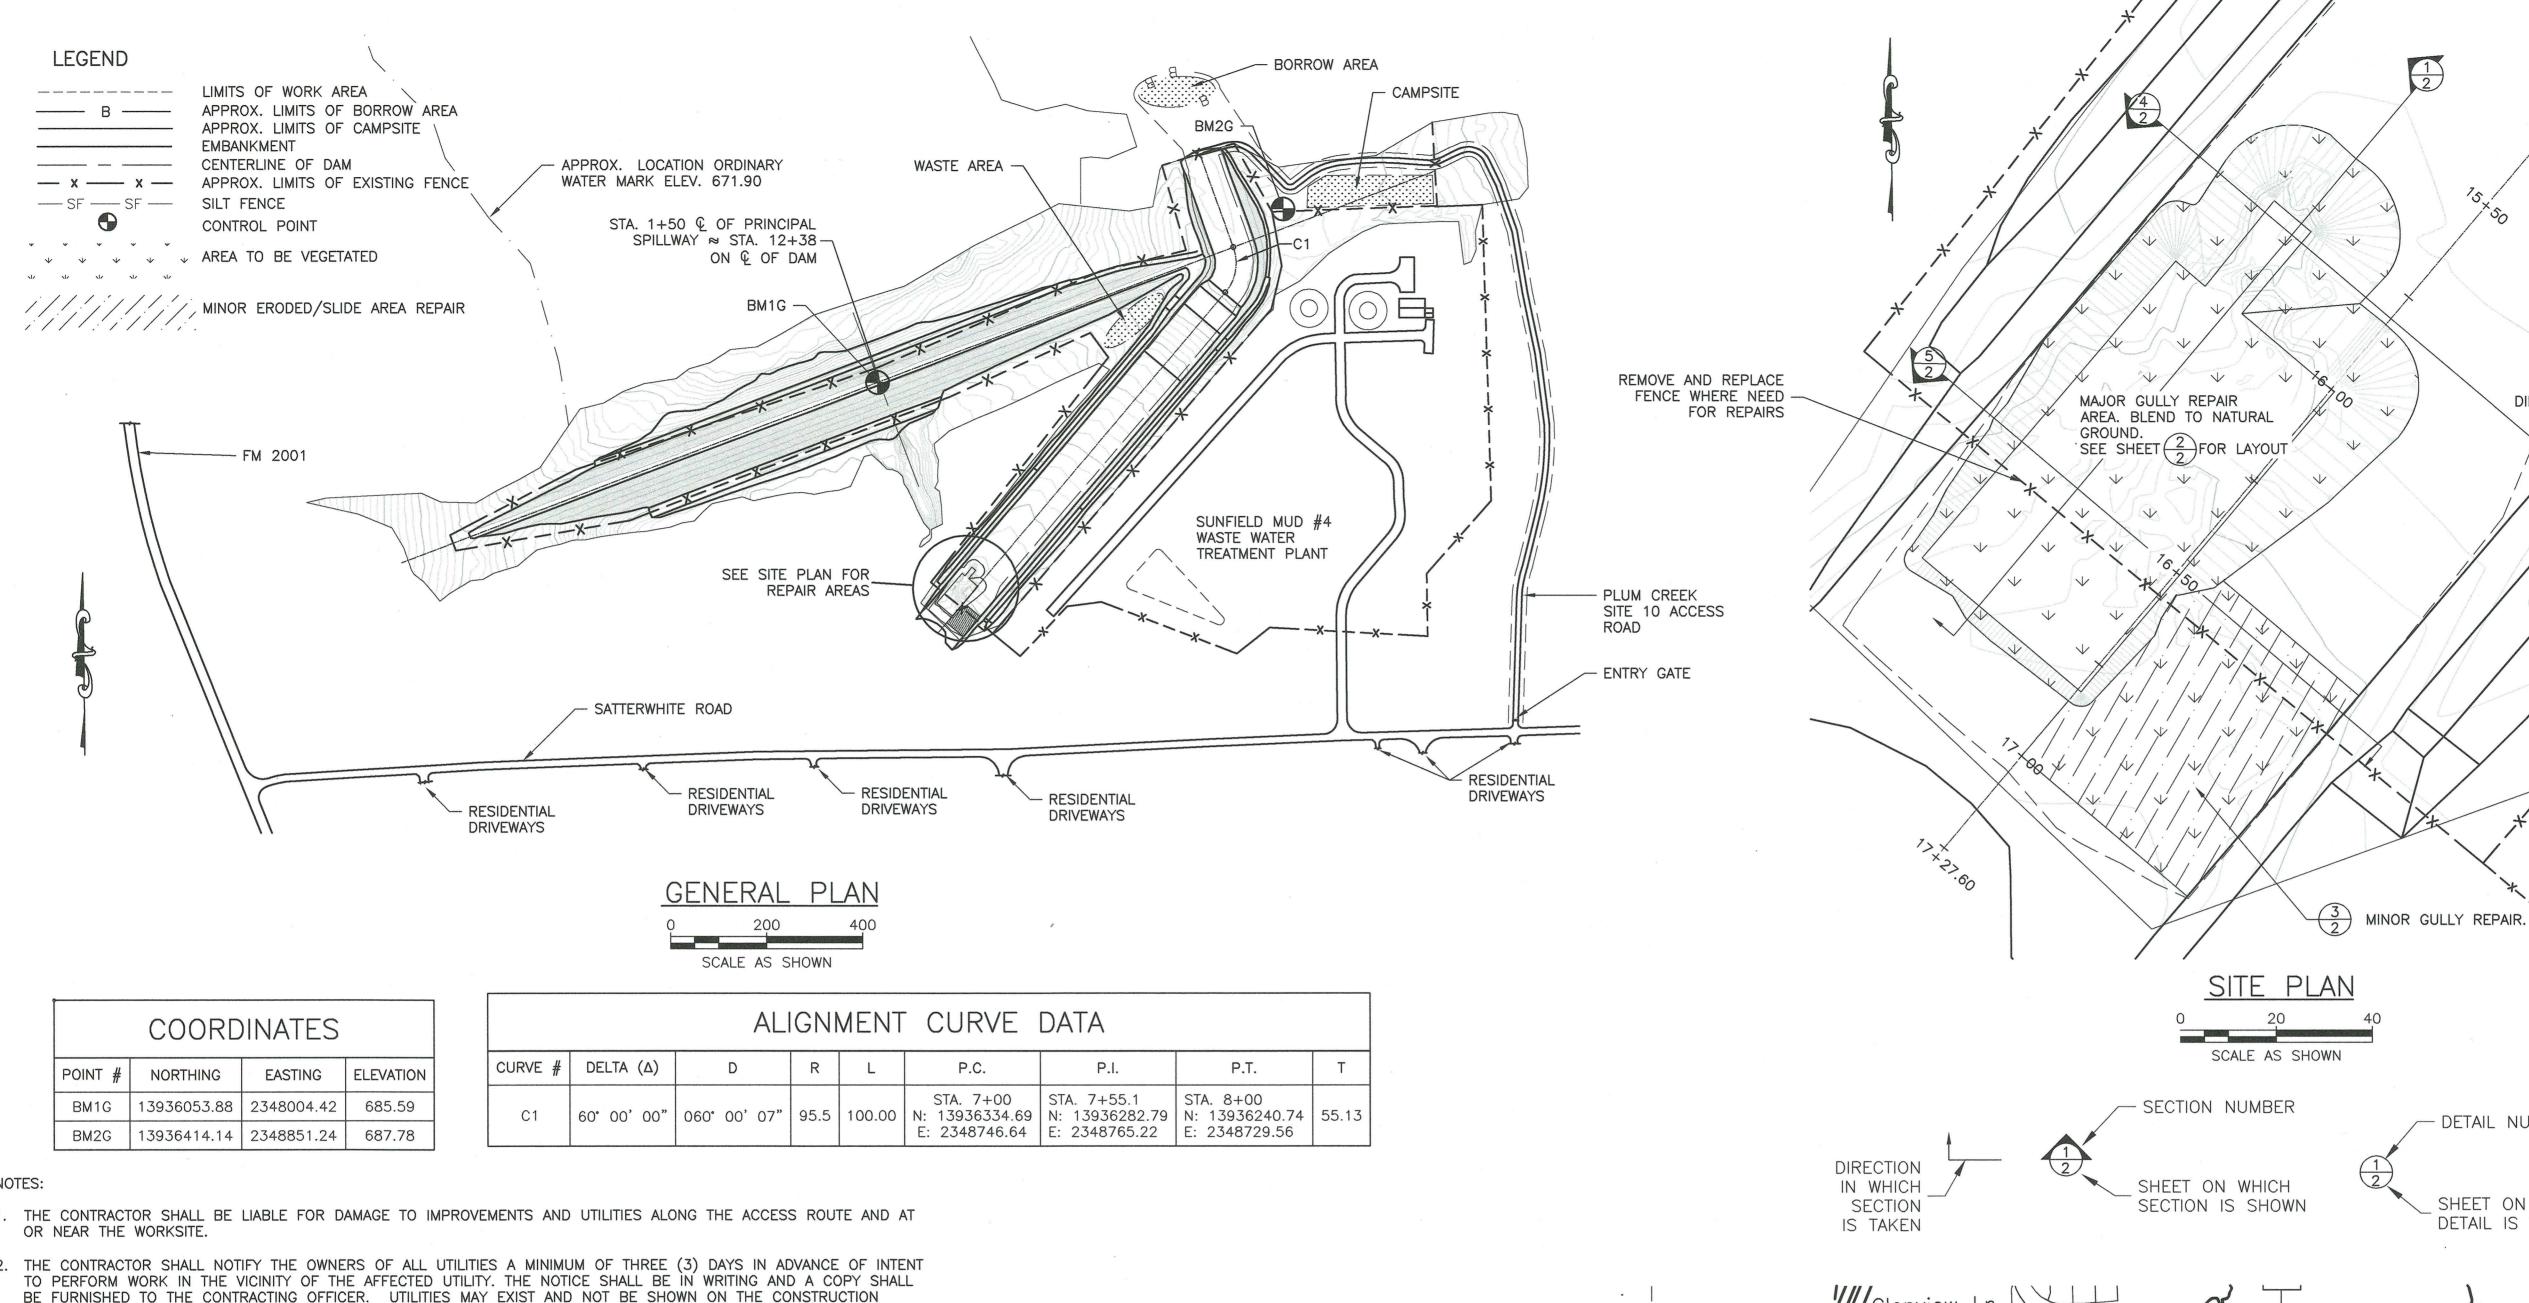

- 1. THE CONTRACTOR SHALL BE LIABLE FOR DAMAGE TO IMPROVEMENTS AND UTILITIES ALONG THE ACCESS ROUTE AND AT
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DIKE TOE -

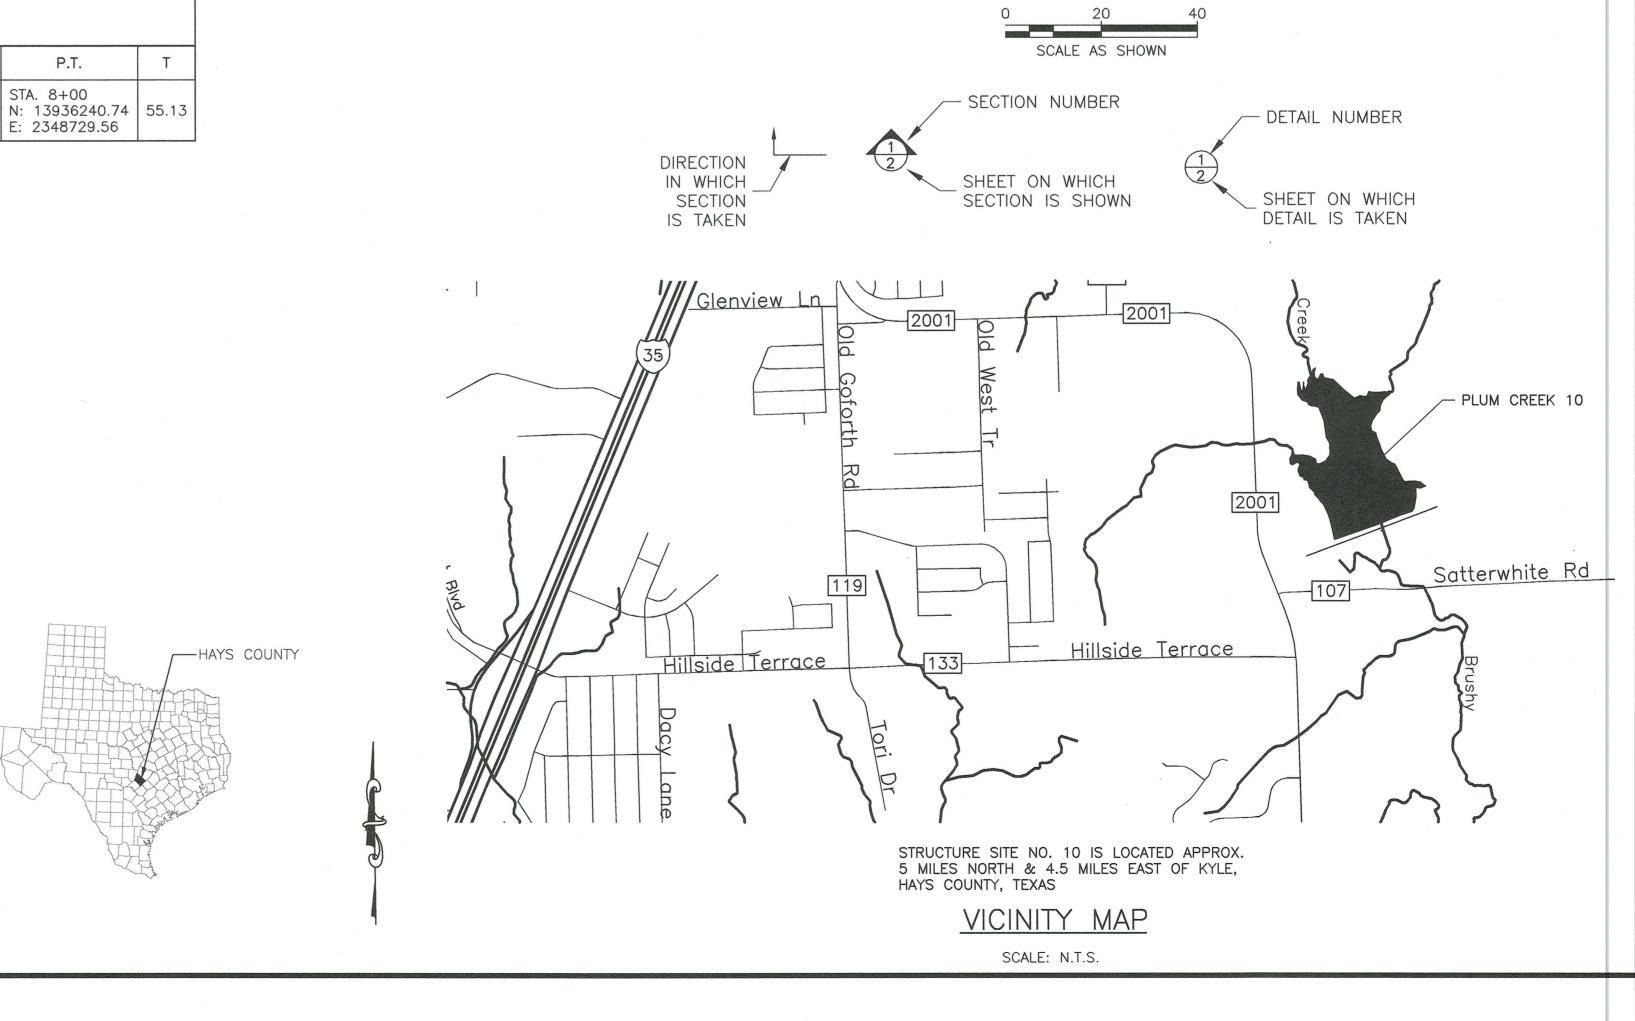DIKE CREST

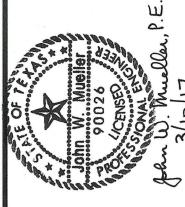DIKE/CREST

એ SITE

**REVISIONS** 

DRAWING NO. TX-EN-0705

SHEET

ERODED/SLIDE AREA (MATCH TO EXISTING GRADE) 5.0' 5.0' MAX. MAX. **FINISHED** -GRADE NATURAL -GROUND EARTHFILL

CONSTRUCTION NOTES:

1. THE APPROXIMATE LOCATIONS AND AREAS OF THE SLIDE/ERODED AREAS TO BE REPAIRED BY SHAPING AND SMOOTHING ARE SHOWN IN THE DRAWINGS. THE FINAL EXTENTS SHALL BE STAKED BY THE ENGINEER.


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3. THE GULLY AREAS SHALL BE REPAIRED IN ACCORDANCE WITH CONSTRUCTION SPECIFICATION 420, BRINGING THE FINISHED SURFACE UP TO MATCH THE EXISTING GRADE.

# 3 TYP. MINOR GULLY REPAIR DETAIL


NOT TO SCALE


1. ALL AREAS WITHIN THE TRANSITION AREA SHALL BE BLENDED TO NATURAL GROUND. ACCORDING TO SPEC. 420,

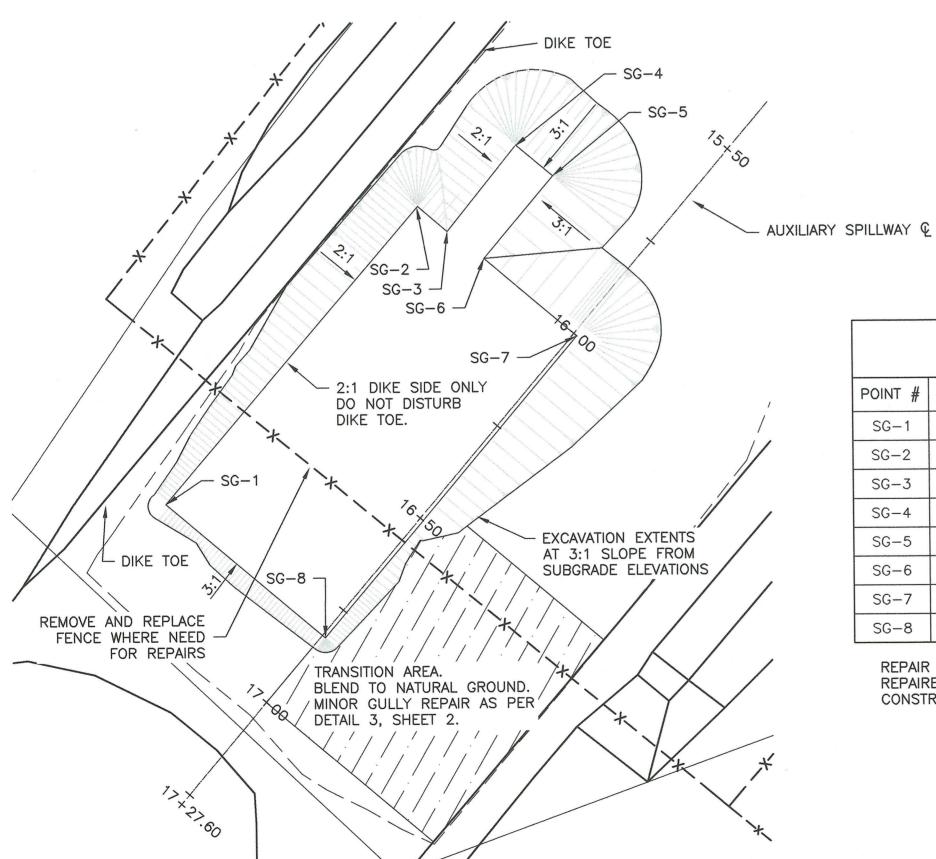



COORDINATES							
POINT #	NORTHING	EASTING	ELEVATION				
SG-1	13935595.65	2348126.90	651.72				
SG-2	13935657.29	2348179.80	651.72				
SG-3	13935652.03	2348185.91	651.72				
SG-4	13935669.90	2348200.38	651.72				
SG-5	13935663.43	2348208.00	651.72				
SG-6	13935646.37	2348193.54	651.72				
SG-7	13935630.09	2348212.75	651.72				
SG-8	13935567.71	2348159.84	651.72				

REPAIR TO EXCAVATION EXTENTS. TO BE REPAIRED IN ACCORDANCE WITH CONSTRUCTION SPECIFICATION 420.

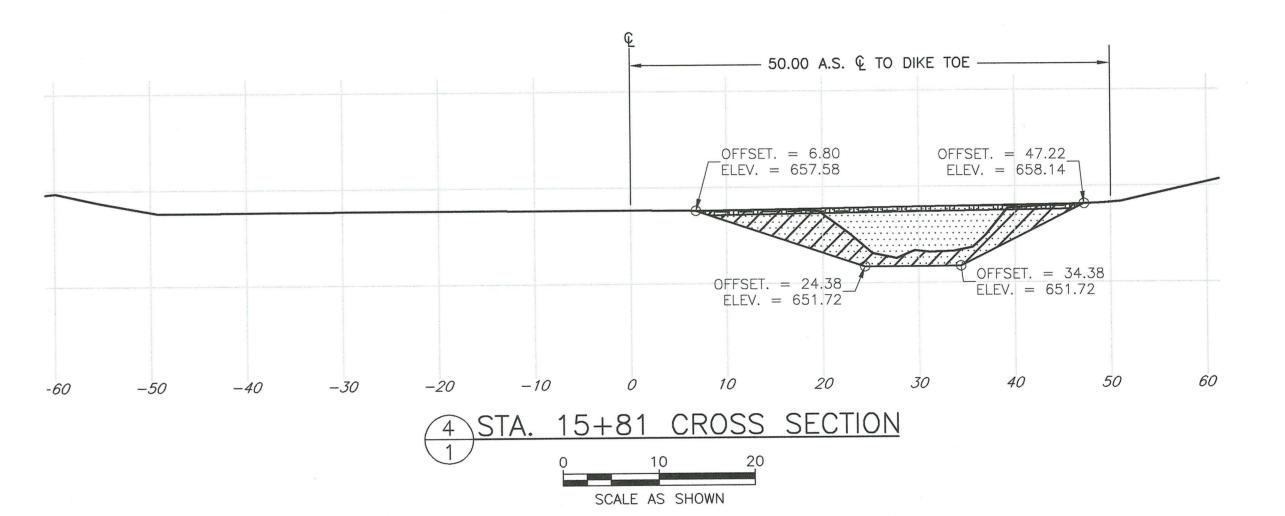

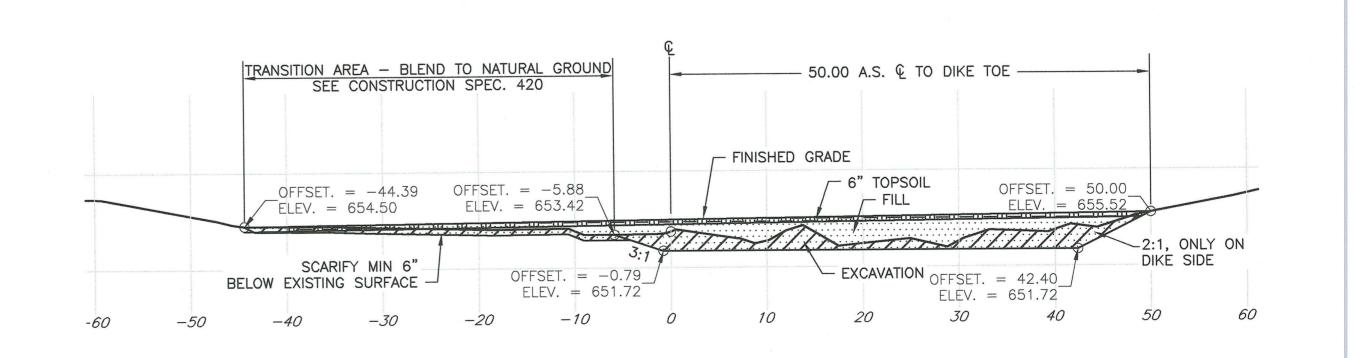

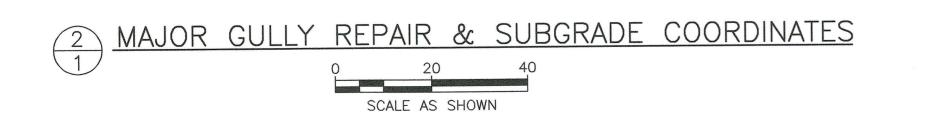

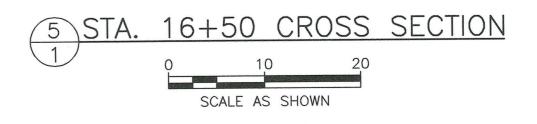



DETAILS GULLY AND SECTIONS

**REVISIONS** 

DRAWING NO. TX-EN-0705

PRIVATE ROAD

SEE VICINITY MAP

FOR ACCESS ROAD ENTRY

RESIDENTIAL STRUCTURES

LEGEND

- - - BORROW AREA

----- CENTERLINE OF AUXILIARY SPILLWAY - x - x - x - APPROX. LIMITS OF EXISTING FENCE

—sf—sf—sf—sf— APPROX. LIMITS OF SILT FENCE

**VEGETATION** 

MINOR GULLY REPAIR

CONTROL POINT

---- WORK LIMITS

REVISIONS

CR RD 120 / WILLIAMSON RD

STRUCTURE SITE NO. 11 IS LOCATED APPROX.

5 MILES NORTHWEST OF NIEDERWALD, HAYS

VICINITY MAP

SCALE: N.T.S.

COUNTY, TEXAS

DRAWING NO.

TX-EN-0704 SHEET

MAJOR GULLY REPAIR AREA. APPROXIMATE MIN. GRADING EXTENTS. SEE SHEET 2 & 3 FOR SECTIONS / DETAILS. SATTERWHITE RD / CR RD 107 DIKE TOE WORK LIMITS 220 LF SILT FENCE SEE TYP. DETAIL  $\left(\frac{5}{3}\right)$  FOR MINOR GULLY REPAIR DIKE TOE PLUM CREEK SITE NO.11 CR RD 107 / SATTERWHITE RD SITE 11 ACCESS ROAD

PLUM CREEK SITE NO.12

John W. Mueller 90026 90026 CENSED

AAWN BY:
SMD

HECKED BY:
CE NAME: PLUM CREEK 11 EPW DESIGN.dwg

NTE CHECKED: 02/2017

MAJOR & MINOR GULLY PROFILE
LOODWATER RETARDING STRUCTURE SITE NO
PLUM CREEK WATERSHED



ted States Department of Agriculture ural Resources Conservation Service

REVISIONS DATE


N/A N/


N/A N/

N/A N/

DRAWING NO.
TX-EN-0704


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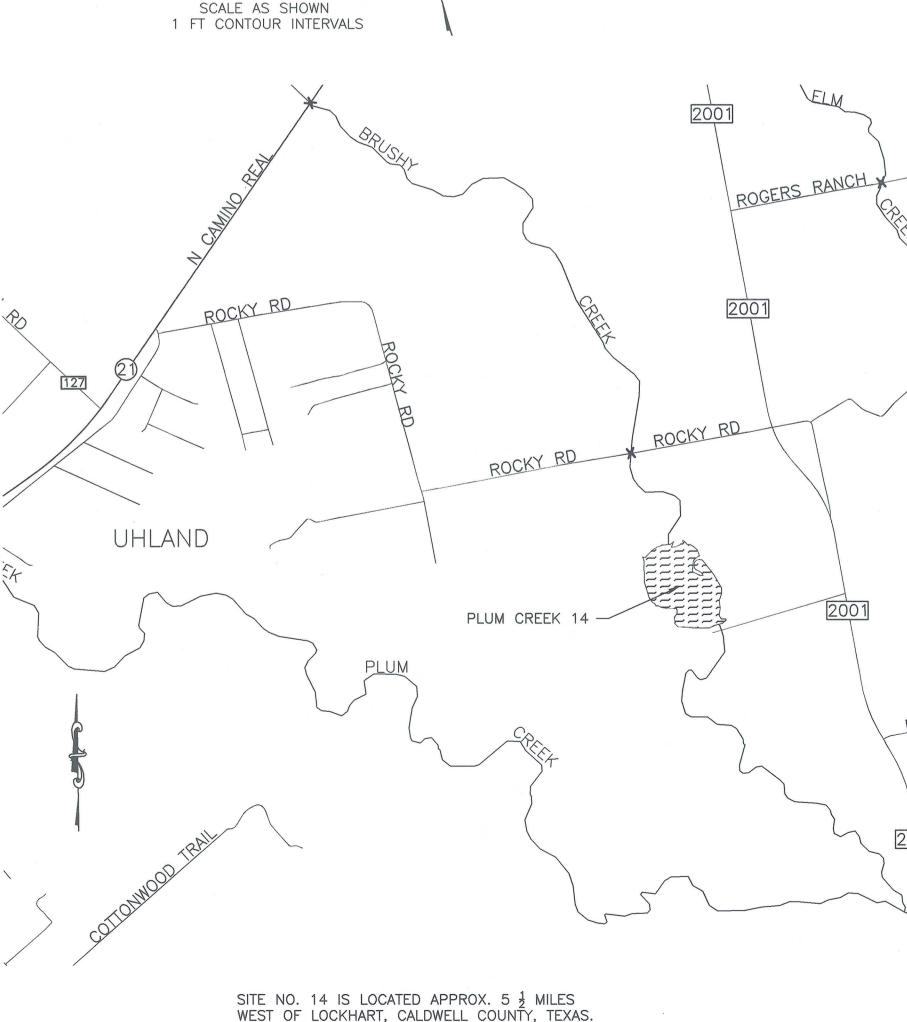


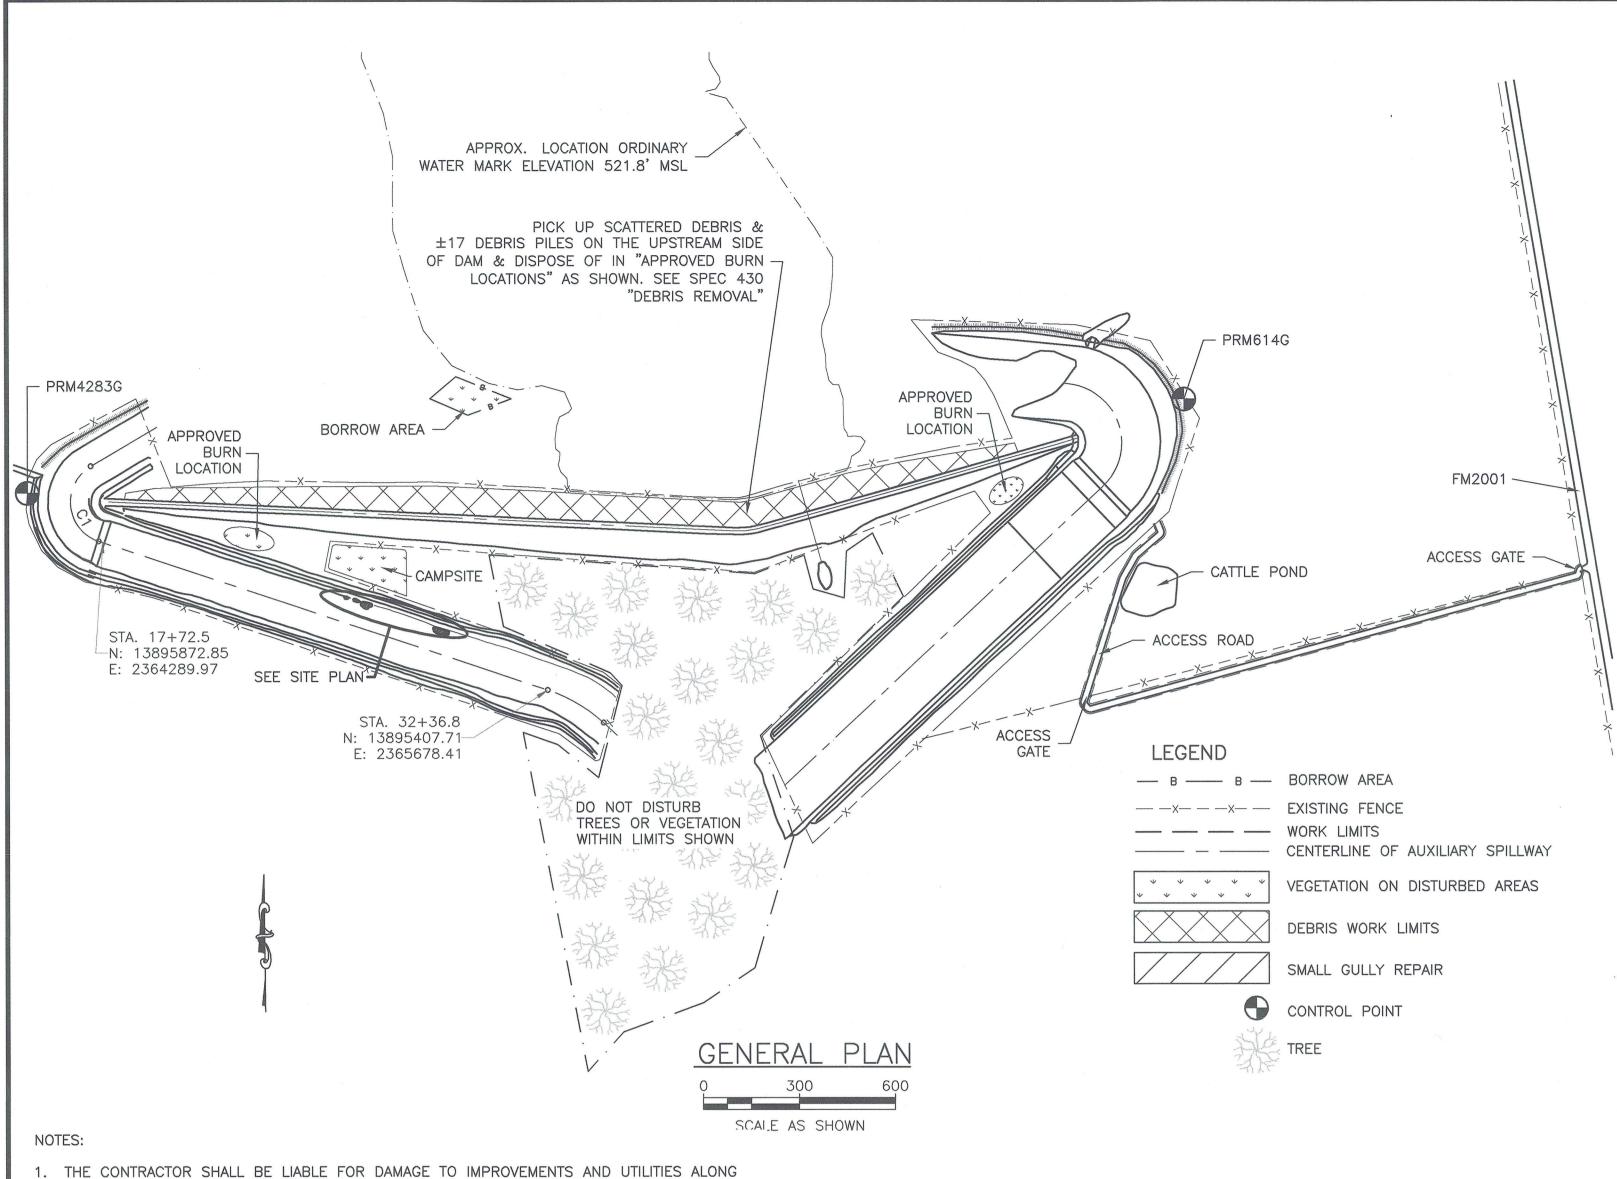

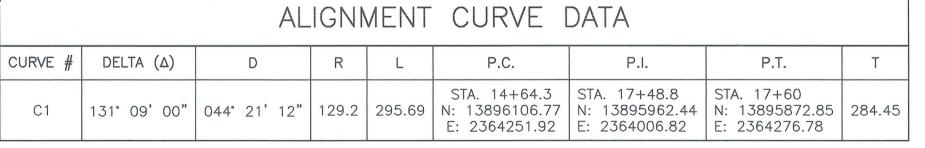COORDINATES							
DESC	NORTHING	EASTING	ELEVATION				
PRM614G	13896314.29	2367668.56	553.63				
PRM4283G	13896022.84	2364053.16	541.43				

COORDINATES							
DESC	NORTHING	EASTING	ELEVATION				
PRM614G	13896314.29	2367668.56	553.63				
PRM4283G 13896022.84 2364053.16 541.43							



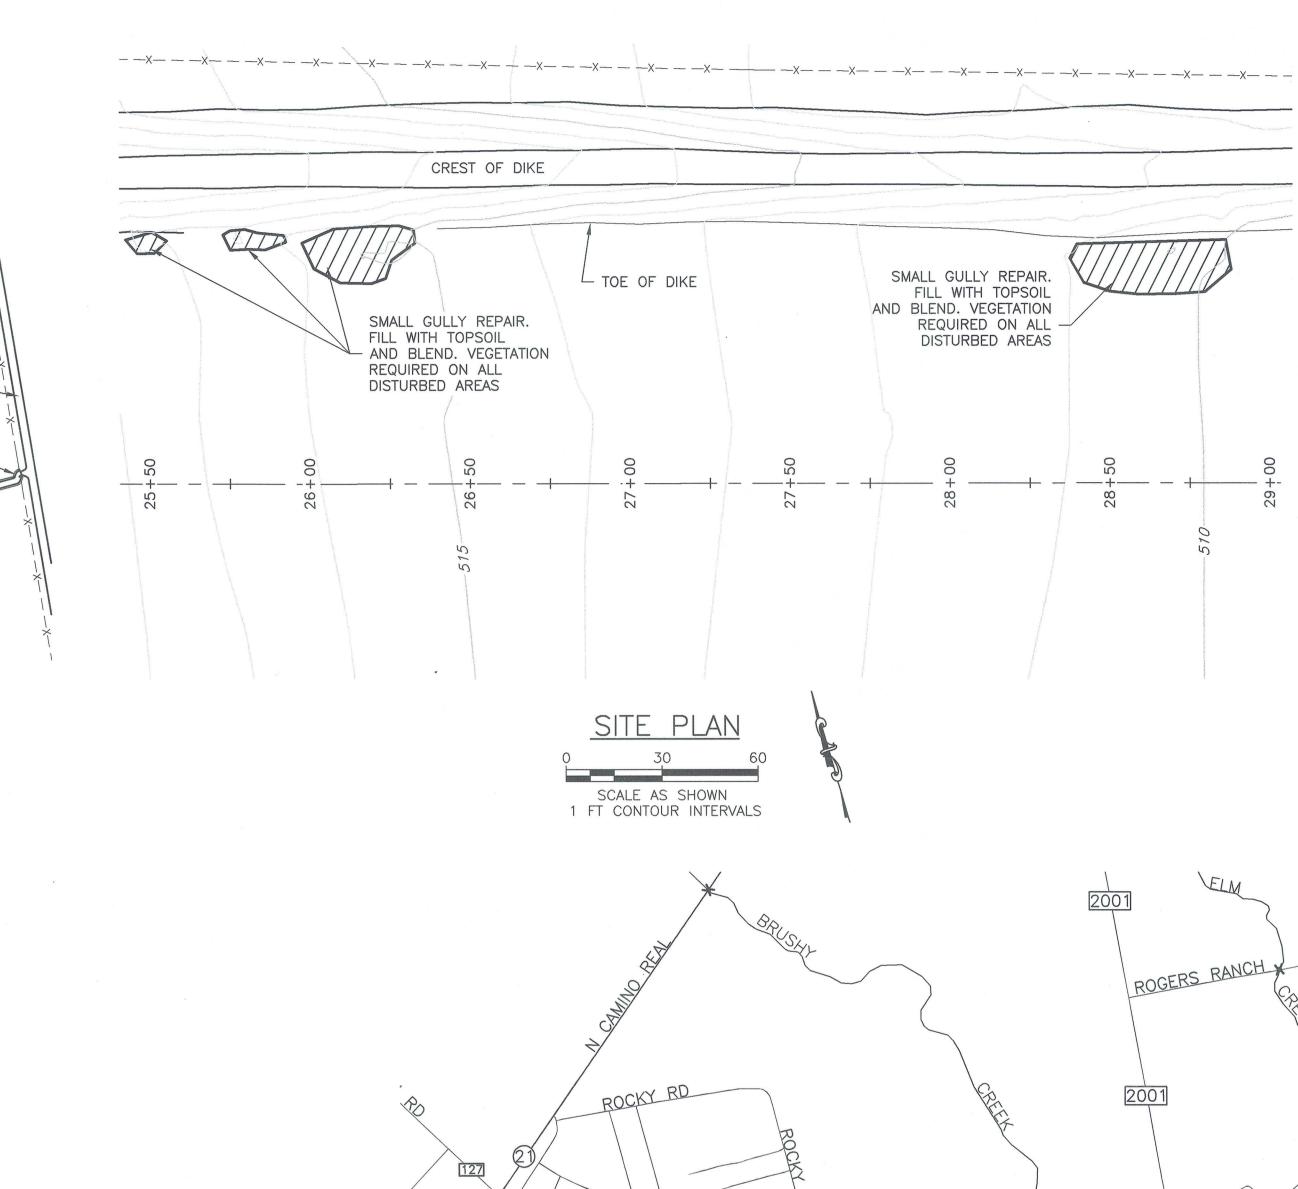

VICINITY MAP

NOT TO SCALE

SMALL GULLY REPAIR.


AND BLEND. VEGETATION


FILL WITH TOPSOIL


REQUIRED ON ALL

DISTURBED AREAS

TOE OF DIKE

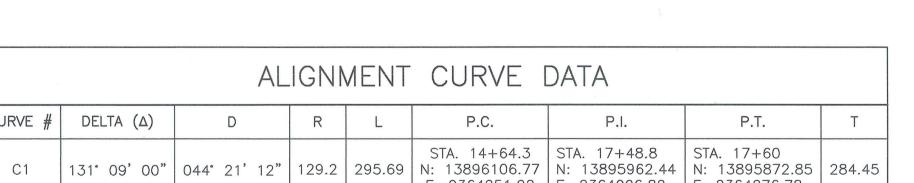

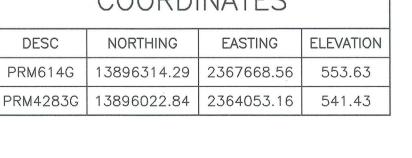

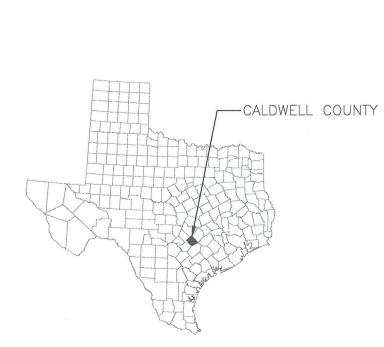



REVISIONS

TX-EN-0702

10. THE CONTROL POINTS SHOWN ARE TO BE USED TO ESTABLISH HORIZONTAL AND VERTICAL CONTROL.

9. THE EXISTING NATURAL GROUND SHOWN FOR THE SITE IS BASED ON SURVEYED CONDITIONS

CONSTRUCTION MAY NECESSITATE ADJUSTMENTS TO THE GRADES AND ELEVATIONS SHOWN.

APPROXIMATE AND SHALL BE ADJUSTED IN THE FIELD BY THE ENGINEER TO BEST FIT THE

THE FINAL GRADES AND ELEVATIONS FOR ALL WORKS OF IMPROVEMENTS SHOWN ARE

AS THEY EXISTED IN FEBRUARY 2016. CHANGES IN SITE CONDITIONS PRIOR TO

THE ACCESS ROUTE AND AT OR NEAR THE WORKSITE.

UNDERGROUND UTILITIES IN THE WORK AREA.

CONSTRUCTION SPECIFICATIONS 21, 23, AND 420).

AND/OR ROCK. (SEE CONSTRUCTION SPECIFICATION 420.)

CONSTRUCTION SPECIFICATION 9).

CONSTRUCTION SPECIFICATION 26).

UNLESS OTHERWISE AUTHORIZED.

TOPOGRAPHY OF THE SITE, IF NECESSARY.

2. THE CONTRACTOR SHALL NOTIFY THE OWNERS OF ALL UTILITIES A MINIMUM OF THREE (3)

TO ANY GROUND DISTURBANCE, THE TELEPHONE NUMBER 811 SHALL BE CALLED TO

TELEPHONE NUMBER WILL ONLY ASCERTAIN THE EXISTENCE OF UNDERGROUND UTILITIES

OWNED BY COMPANIES THAT SUBSCRIBE TO THIS ORGANIZATION. THERE MAY BE OTHER

3. THE APPROXIMATE LOCATIONS OF THE ACCESS ROAD, CONSTRUCTION CAMPSITE, STOCKPILE,

4. THE CONTRACTOR SHALL BE RESPONSIBLE FOR FURNISHING, INSTALLING, AND MAINTAINING ALL BARRICADES, WARNING SIGNS, TRAFFIC CONTROL DEVICES, ETC. NECESSARY TO CONTROL

EARTHFILL MATERIALS. UNSUITABLE MATERIALS SHALL BE PLACED IN A WASTE AREA OR OTHER AREAS APPROVED BY THE ENGINEER. EARTH MATERIALS NEEDED IN EXCESS OF

6. A MINIMUM OF 6" OF TOPSOIL SHALL BE PLACED ON ALL EARTHWORK REPAIR AREAS (SEE

DESIGNATED AT THE TIME OF SHOWING OF THE WORKSITE TO PROSPECTIVE BIDDERS.

TRAFFIC AND PROVIDE FOR PUBLIC SAFETY AT THE ENTRANCE TO THE SITE (SEE

5. SUITABLE MATERIAL FROM EXCAVATIONS SHALL BE PROCESSED AND USED FOR THE

REQUIRED EXCAVATIONS SHALL BE OBTAINED FROM THE BORROW AREA(S). (SEE

7. CONSTRUCTION ACTIVITIES SHALL NOT OCCUR OUTSIDE THE DESIGNATED WORK LIMITS,

8. REMOVAL OR STRIPPING OF SOIL MATERIALS INCLUDING TOPSOIL AND LOW DENSITY OR

DISPLACED MATERIALS WILL BE NECESSARY TO PROVIDE A SUITABLE WORKING AREA FOR THE CONSTRUCTION EQUIPMENT. THE APPROXIMATE LIMITS OF THE REMOVAL ARE SHOWN ON THE DRAWINGS. REMOVAL OF ADDITIONAL MATERIALS BEYOND THE LIMITS SHOWN MAY BE REQUIRED TO ENSURE A SUITABLE FOUNDATION EXISTS ON WHICH TO PLACE EARTHFILL

DAYS IN ADVANCE OF INTENT TO PERFORM WORK IN THE VICINITY OF THE AFFECTED UTILITY. THE NOTICE SHALL BE IN WRITING AND A COPY SHALL BE FURNISHED TO THE CONTRACTING OFFICER. UTILITIES MAY EXIST AND NOT BE SHOWN ON THE CONSTRUCTION DRAWINGS. THE SITE SHALL BE CAREFULLY SCRUTINIZED FOR EVIDENCE OF UTILITIES. AT A MINIMUM. PRIOR

ASCERTAIN IF UNDERGROUND UTILITIES EXIST IN THE GENERAL WORK AREA. CALLING THIS

BORROW AND WASTE AREAS ARE SHOWN. THE FINAL LOCATIONS OF THESE AREAS SHALL BE